

PACIFIC STEEL & RECYCLING ARENA FACADES REMODEL

400 3rd Street Northwest
GREAT FALLS, MONTANA, 49404



GENERAL PROJECT NOTES	
NOTE #	DESCRIPTION
1	GENERAL CONTRACTOR SHALL VERIFY DIMENSIONS AND CONDITIONS OF EXISTING BUILDING.
2	THE TERM "CONTRACTOR" REFERS TO THE GENERAL CONTRACTOR UNLESS OTHERWISE NOTED.
3	ALL SHOP DRAWING DIMENSIONS TO BE CHECKED AND VERIFIED IN THE FIELD BY THE CONTRACTOR WHO WILL BE RESPONSIBLE FOR SAME.
4	GENERAL CONTRACTOR IS RESPONSIBLE FOR PATCHING OF ALL HOLES OR DAMAGE ENCOUNTERED IN WORK DONE BY HIMSELF OR ANY OTHER TRADE OR CONTRACTOR.
5	GENERAL CONTRACTOR SHALL BE RESPONSIBLE FOR THE COMPLETE REPAIR AND REFINISHING OF ALL WORK TO MATCH EXISTING CONDITIONS AS A RESULT OF NECESSARY CUTTING, PATCHING, OR DEMOLITION BY ALL TRADES WHILE PERFORMING THE WORK.
6	GENERAL CONTRACTOR TO PROVIDE ALL REQUIRED BLOCKING, ANCHORAGES FOR ACCESSORIES.
7	CONSTRUCTION LIMIT LINE IS APPROXIMATE, ACCESS TO OTHER AREAS AS REQUIRED BY WORK IS ACCEPTABLE BY APPROVAL OF ARCHITECT AND OWNER.
8	IN GENERAL, REPETITIVE FEATURES DRAWN TO MORE THAN ONE SCALE ARE SHOWN IN FULL ONLY ONCE AND REPETITIONS ARE NOT COMPLETED IN EVERY DETAIL AS SHOWN IN ORIGINAL INSTANCE.
9	DETAILS WHICH OCCUR BOTH RIGHT AND LEFT HAND ARE SHOWN ONLY ONCE.
10	PARTITIONS ARE LOCATED BY ONE OF THE FOLLOWING METHODS: A). WHERE POSSIBLE, BY RELATIONSHIP ADJACENT TO STRUCTURE. B). TYPICAL RELATIONSHIP TO LARGE SCALE DETAILS. C). BY DIMENSION FROM STRUCTURE OR PARTITION ALREADY LOCATED.
11	WHERE CONDITION OF FINISH ARISES THAT NO DETAIL OR NOTE COVERS, MATCH DETAILS TO EXISTING SITUATION OF SIMILAR CONDITION.
12	ALL PENETRATIONS THROUGH WALLS ARE TO BE CLOSED TIGHT AROUND PENETRATION. CONTRACTOR TO COORDINATE.
13	ALL EXISTING ELECTRICAL CONDUIT TO BE INSTALLED TIGHT TO STRUCTURE WHERE POSSIBLE IN ALL INSTANCES IF APPLICABLE.
14	NO MATERIALS OR TOOLS MAY BE LEFT IN SPACES NOT REQUIRING WORK. ANY DIRT OR MATERIALS DROPPED ENROUTE TO WORK AREAS MUST BE CLEANED IN EXISTING BUILDING DAILY.
15	DAMAGE TO EXISTING: ANY AND ALL DAMAGES CAUSED BY THE CONTRACTOR AND/OR PEOPLE UNDER DIRECT SUPERVISION OF THE CONTRACTOR SHALL BE REPLACED AND/OR REPAIRED AT CONTRACTOR'S EXPENSE WITH NO COST INFRACTION ON THE OWNER.

GENERAL ABBREVIATIONS	
ABBREVIATION	DESCRIPTION
AB	ANCHOR BOLT
ABI	ALTERNATE BID ITEM
AC	ACOUSTICAL
ACCESS	ACCESSIBLE
ACT	ACOUSTICAL CEILING TILE
ADJ	ADJUSTABLE
ALT	ALTERNATE
ARCH	ARCHITECT(URAL)
BLDG	BUILDING
BLKG	BLOCKING
BM	BENCH MARK
BIM	BUILDING INFORMATION MODELING
BOS	BOTTOM OF STRUCTURE
BO	BOTTOM OF ...
CAB	CABINET
CJ	CONTROL JOINT
CLG	CEILING
COL	COLUMN
CONC	CONCRETE
CONST	CONSTRUCTION
CONT	CONTINUOUS
CONTR	CONTRACTOR
CPT	CARPET
DEMO	DEMOLISH, DEMOLITION
DF	DRINKING FOUNTAIN
DIA	DIAMETER
DIM	DIMENSION
DTL	DETAIL
DWG	DRAWING
ELEV	ELEVATION
EQ	EQUAL
EST	ESTIMATE
EXIST	EXISTING
EXP	EXPOSED
EXPJT	EXPANSION JOINT
EXT	EXTERIOR
FA	FIRE ALARM
FBO	FURNISHED BY OWNER
FD	FLOOR DRAIN
FE	FIRE EXTINGUISHER
FEC	FIRE ALARM CABINET
FIN	FINISH (ED,ING)
FLR	FLOOR
FO	FACE OF ...
FOC	FACE OF CONCRETE
FOS	FACE OF STUD
FP	FIRE PROOF
FR	FIRE RATED
FRP	FIBERGLASS REINFORCED PLASTIC
FTG	FOOTING
FUR	FURRED (ING)
GA	GAUGE
GT	GENERAL CONTRACTOR
GWB	GYPSTUM WALL BOARD
HC	HOLLOW CORE
HM	HOLLOW METAL
HOR	HORIZONTAL
HTG	HEATING
HVAC	HEATING VENTILATION AIR CONDITIONING
INCL	INCLUDED
ID	INSIDE DIAMETER
INSUL	INSULATION
INT	INTERIOR
JT	JOINT

GENERAL ABBREVIATIONS	
ABBREVIATION	DESCRIPTION
LAV	LAVITORY
MAT'L	MATERIAL(S)
MAX	MAXIMUM
MBR	MEMBER
MECH	MECHANICAL (DWGS,SPECS)
MFR	MANUFACTURER
MIN	MINIMUM
MISC	MISCELLANEOUS
MTL	METAL
NIC	NOT IN CONTRACT
NOM	NOMINAL
NTS	NOT TO SCALE
OC	ON-CENTER
OPNG	OPENING
OPP	OPPOSITE
OS	OUTSIDE DIAMETER
O/	OVER
OSCI	OWNER SUPPLIED CONTRACTOR INSTALLED
OSOI	OWNER SUPPLIED OWNER INSTALLED
PT	PAINT
PLAM	PLASTIC LAMINATE
PLY	GENERAL PLYWOOD
PRE-FIN	PREFINISHED
PVC	POLYVINYL CHLORIDE
QTY	QUANTITY
RB	RUBBER BASE
REF	REFERENCE
REINF	REINFORCE (ED,ING)
REV	REVISION
RO	ROUGH OPENING
SC	SOLID CORE
SCW	SOLID CORE WOOD
SCHED	SCHEDULE
SHT	SHEET
SIM	SIMILAR
SPEC'D	SPECIFIED
SPEC	SPECIFICATIONS
SQ	SQUARE
STD	STANDARD
STOR	STORAGE
STRUCT	STRUCTURAL (DWGS, SPECS)
SYS	SYSTEM
SV	SHEET VINYL
TD	TRENCH DRAIN
TEL	TELEPHONE
T&G	TONGUE AND GROOVE
TOW	TOP OF WALL
TO	TOP OF ...
TYP	TYPICAL
UNFIN	UNFINISHED
UNO	UNLESS NOTED OTHERWISE
VB	VAPOR BARRIER
VCT	VINYL COMPOSITE TILE
VER	VERIFY
VERT	VERTICAL
VIF	VERIFY IN FIELD
WC	WATER CLOSET
WD	WOOD
W/D	WASHER AND DRYER
WB	WOOD BASE
WH	WATER HEATER
W/	WITH
W/O	WITHOUT

01 GENERAL
THIS PROJECT CONSIST OF THE REMOVAL OF EXISTING EFIS AT THE FACADE ENTRANCES SOUTH, SOUTHWEST AND WEST AND THE NORTH SIDE MALL. REPLACE ALL EFIS AS SHOWN WITH PRE-FINISHED 26 GAUGE METAL SIDING.

02 PROJECT TYPE: (CHECK ALL THAT APPLY.)
☐ NEW BUILDING
☒ REPAIR
☐ ALTERATION LEVEL 0
☐ CHANGE OF OCCUPANCY

☐ ADDITION
☐ HISTORIC BUILDING
☐ EXISTING BUILDING CODE CHAPTER 15 COMPLIANCE ALTERNATIVES

03 WORK (CHECK ALL THAT APPLY.)
☒ GENERAL CONSTRUCTION
☐ STRUCTURAL
☐ PLUMBING
☐ MECHANICAL
☐ ELECTRICAL
☐ ABATEMENT/ENVIRONMENTAL
☐ FIRE ALARM SYSTEMS
☐ SPRINKLERS
☐ ELEVATOR
☐ SITEWORK
☐ OTHER

04 APPLICABLE BUILDING
2010 INTERNATIONAL BUILDING CODE
2011 NATIONAL ELECTRIC CODE
2012 INTERNATIONAL ENERGY CONSERVATION CODE
2010 INTERNATIONAL EXISTING BUILDING CODE
2010 UNIFORM PLUMBING CODE
2010 INTERNATIONAL MECHANICAL CODE
2010 INTERNATIONAL FUEL GAS CODE
2009 ANSI A117.1 ACCESSIBILITY & USABLE BUILDINGS

05 FIRE SAFETY

THE EXISTING FACILITY DOES HAVE A FIRE SPRINKLER SYSTEM.

06 BUILDING/PROJECT REMODEL EXTERIOR ENTRANCES AND ELEVATION OF EXISTING PACIFIC STEEL & RECYCLING ARENA

07 OCCUPANCY
☒ ASSEMBLY
☐ BUSINESS
☐ EDUCATIONAL
☐ FACTORY & INDUSTRIAL
☐ HIGH HAZARD
☐ INSTITUTIONAL
☐ MERCANTILE
☐ RESIDENTIAL
☐ STORAGE
☐ UTILITY/MISC.

08 CONSTRUCTION
☐ TYPE I-A
☐ TYPE I-B
☐ TYPE II-A
☐ TYPE II-B
☐ TYPE III
☐ TYPE IV
☐ TYPE V-A
☒ TYPE V-B

SHEET INDEX	
SHEET #	SHEET NAME
CVR	COVER SHEET
SP1.1	SITE PLAN
A1.1	NORTH ELEVATION, ROOF PLAN AND SECTION
A1.2	WEST ENTRANCE - ELEVATIONS, ROOF PLAN AND SECTION
A1.3	SOUTHWEST ENTRANCE - ELEVATIONS, ROOF PLAN AND SECTION
A1.4	SOUTH ENTRANCE - ELEVATIONS, ROOF PLAN AND SECTION
A1.5	SECTION DETAILS

PROJECT TEAM

OWNER: CASCADE COUNTY, MONTANA
GREAT FALLS, MONTANA 59404

ARCHITECTURAL: NELSON ARCHITECTS, LLC
621 2ND AVENUE NORTH
GREAT FALLS, MONTANA 59401
P: 406-727-3286
CONTACT: DALE NELSON, PRINCIPAL
DALE NELSON, PROJECT ARCH
SCOTT KELLER, CONSTRUCTION MANAGER

PROJECT SYMBOLS

VIEW / SHEET REFERENCE

SHEET TITLE

DETAIL TITLE

A1.1

1

View Name

1/8" = 1'-0"

DISCIPLINE SECTION

DETAIL NO. ON SHEET

DISCIPLINE

DETAIL SCALE

DRAWING REFERENCE

SECTION DETAIL

CALL-OUT DETAIL

ELEVATION

1

A1.1

1

A1.1

1

A1.1

TAG REFERENCE

ROOM TAG Room name
101

DOOR TAG 101

WINDOW TAG 101

WALL TAG 101

PROJECT GRID
A 1

DEMO FLAG NOTE
0

SPOT ELEVATION/PROJECT LEVEL
Name
Elevation

ROOM FINISH TAG
CEILING MATERIAL
NORTH WALL FIN.
WEST WALL FIN.
SOUTH WALL FIN.
EAST WALL FIN.

CM99 20'
WF 2
WF 1
WF 3
WF 4
CPT - 1
Name 101

CEILING HEIGHT
BASE MATERIAL
FLOOR FINISH
COMMENTS

Nelson architects
Dream Design Build
621 2nd Avenue North
Great Falls, MT 59401
406.727.3286 • NelsonArchitects.com

PACIFIC STEEL & RECYCLING
ARENA

REVISION SCHEDULE		
#	DESCRIPTION	DATE

COVER SHEET


ISSUED FOR
NOT FOR CONST.

Project 20-025
Date 9.28.20
Drawn by CAJ
Checked by DEN

CVR



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PACIFIC STEEL & RECYCLING ARENA

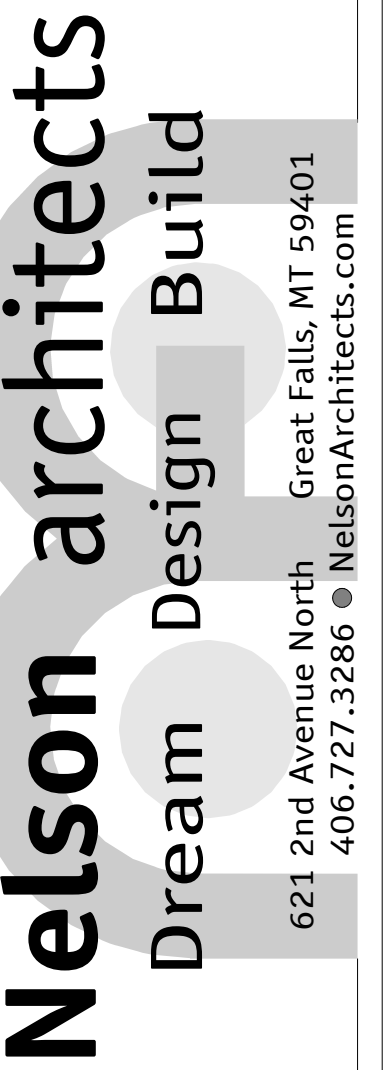REVISION SCHEDULE	
DESCRIPTION	DATE

2017-11-17


ISSUED FOR
☒ NOT FOR CONST. ☐ CONSTRUCTION

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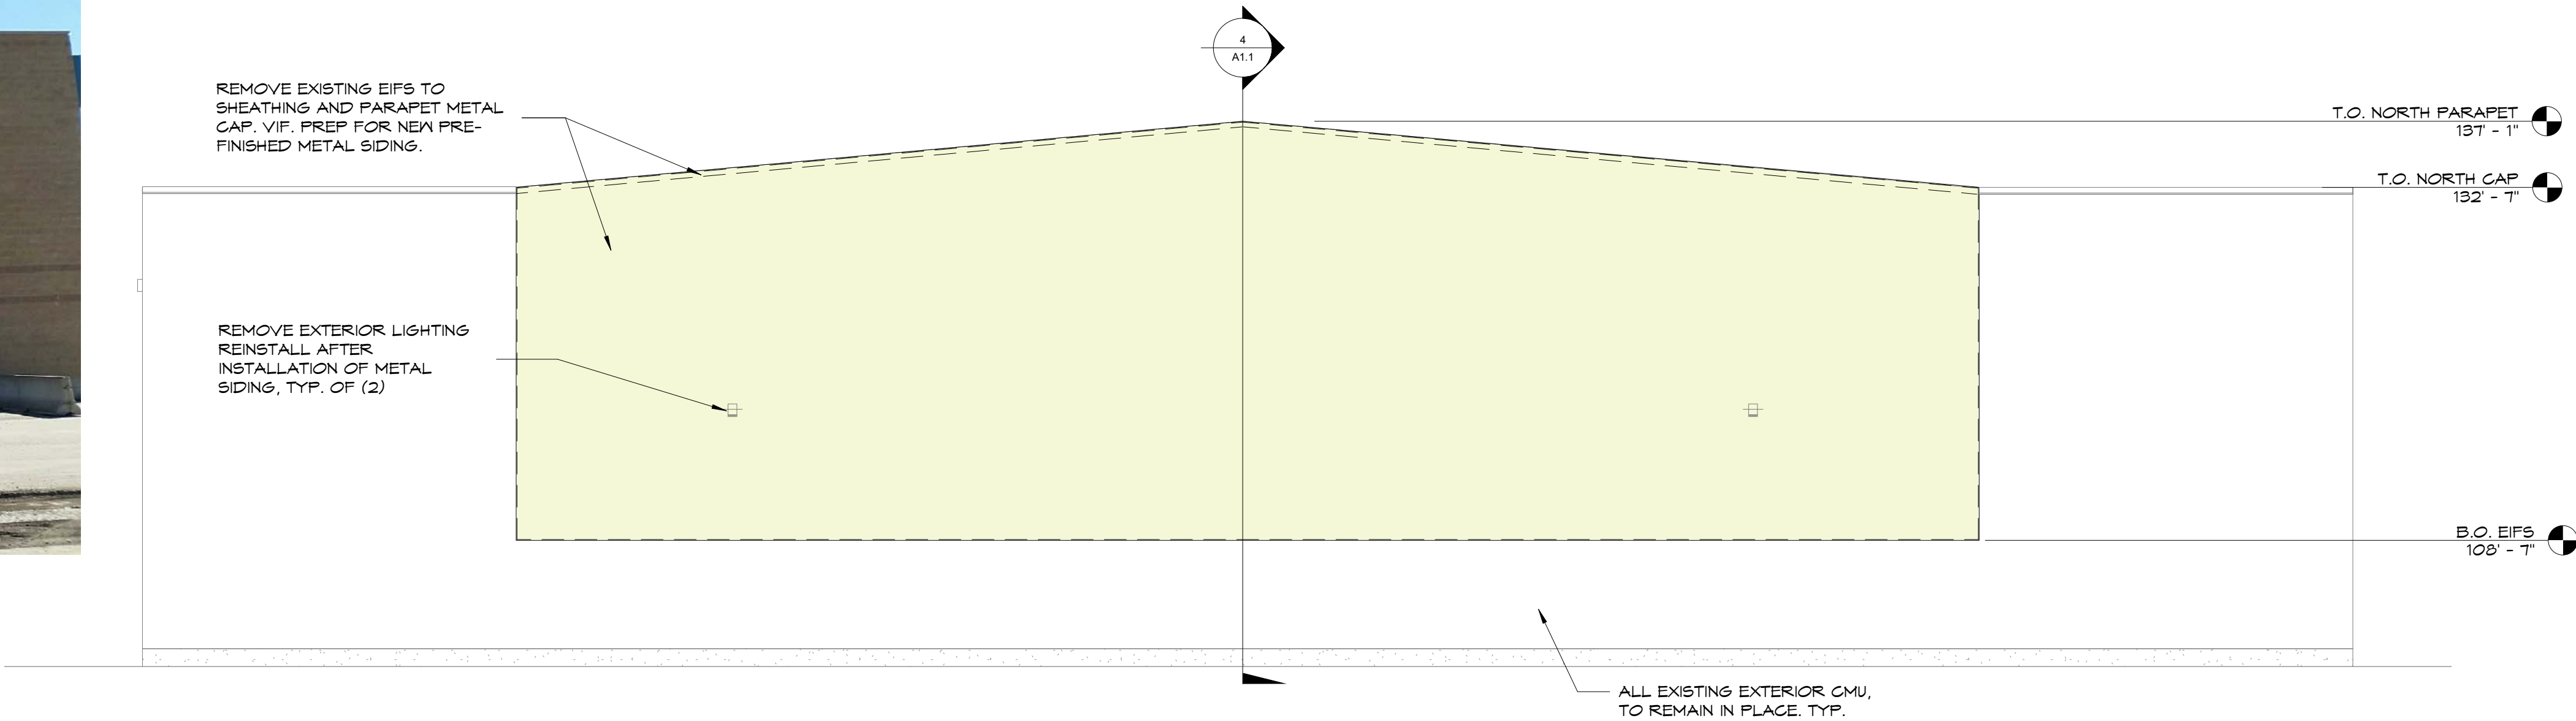
SP1.1




NORTH ENTRANCE

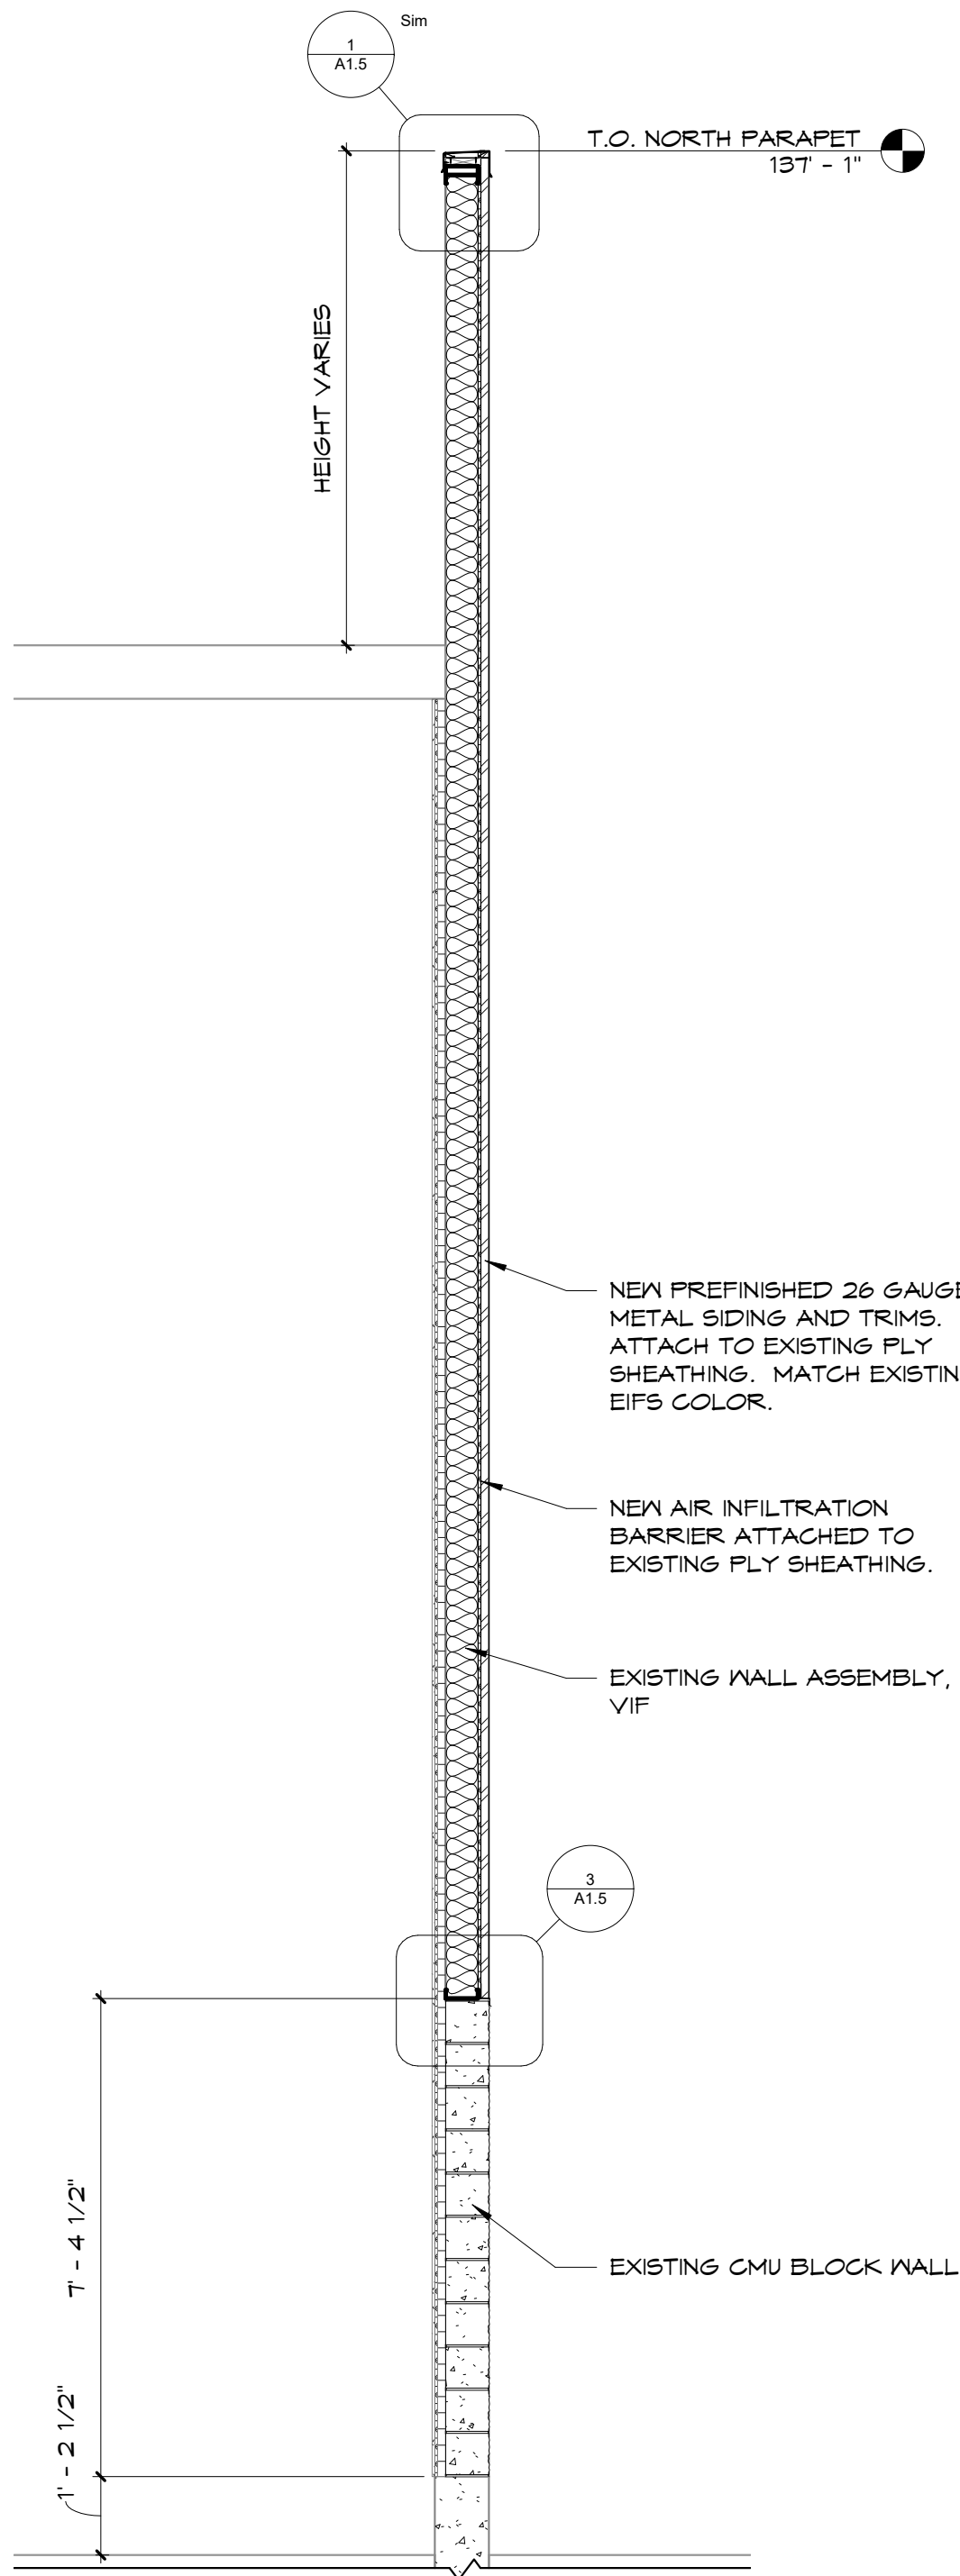


④ NORTH ELEVATION SECTION
3/8" = 1'-0"



① NORTH ELEVATION - DEMOLITION
1/8" = 1'-0"

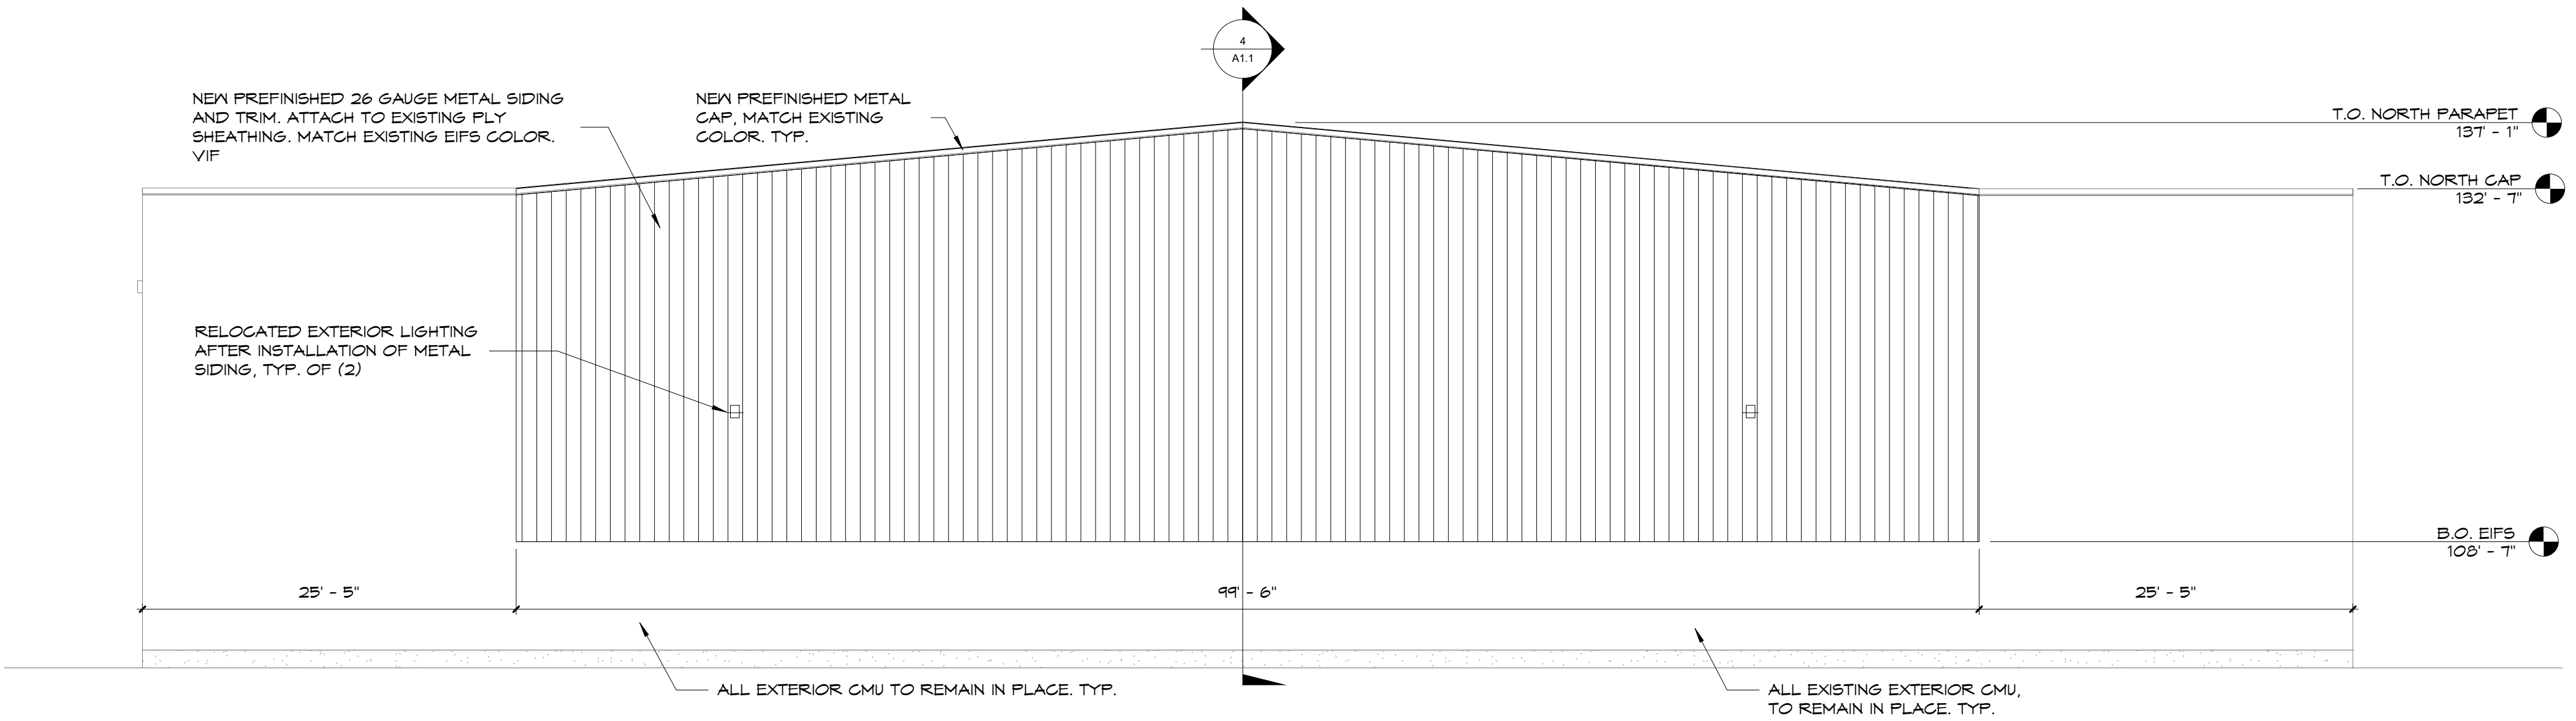

② NORTH ELEVATION - NEW METAL SIDING
1/8" = 1'-0"

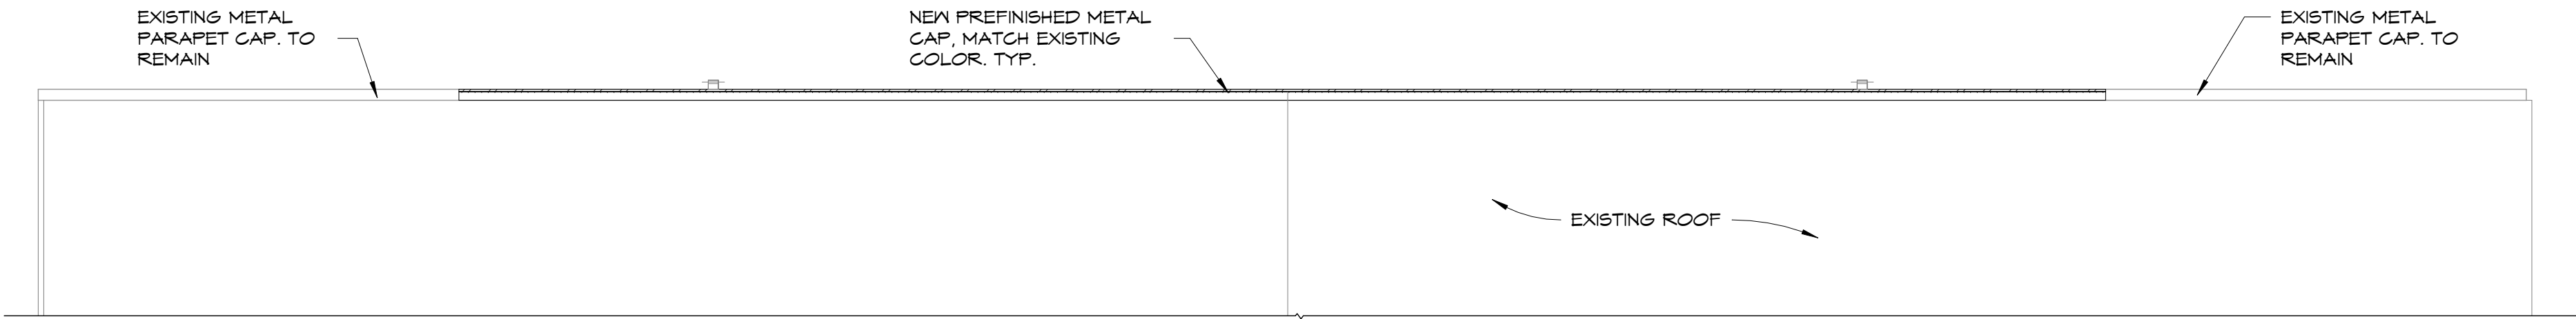

③ ROOF PLAN - NORTH ELEVATION
1/8" = 1'-0"




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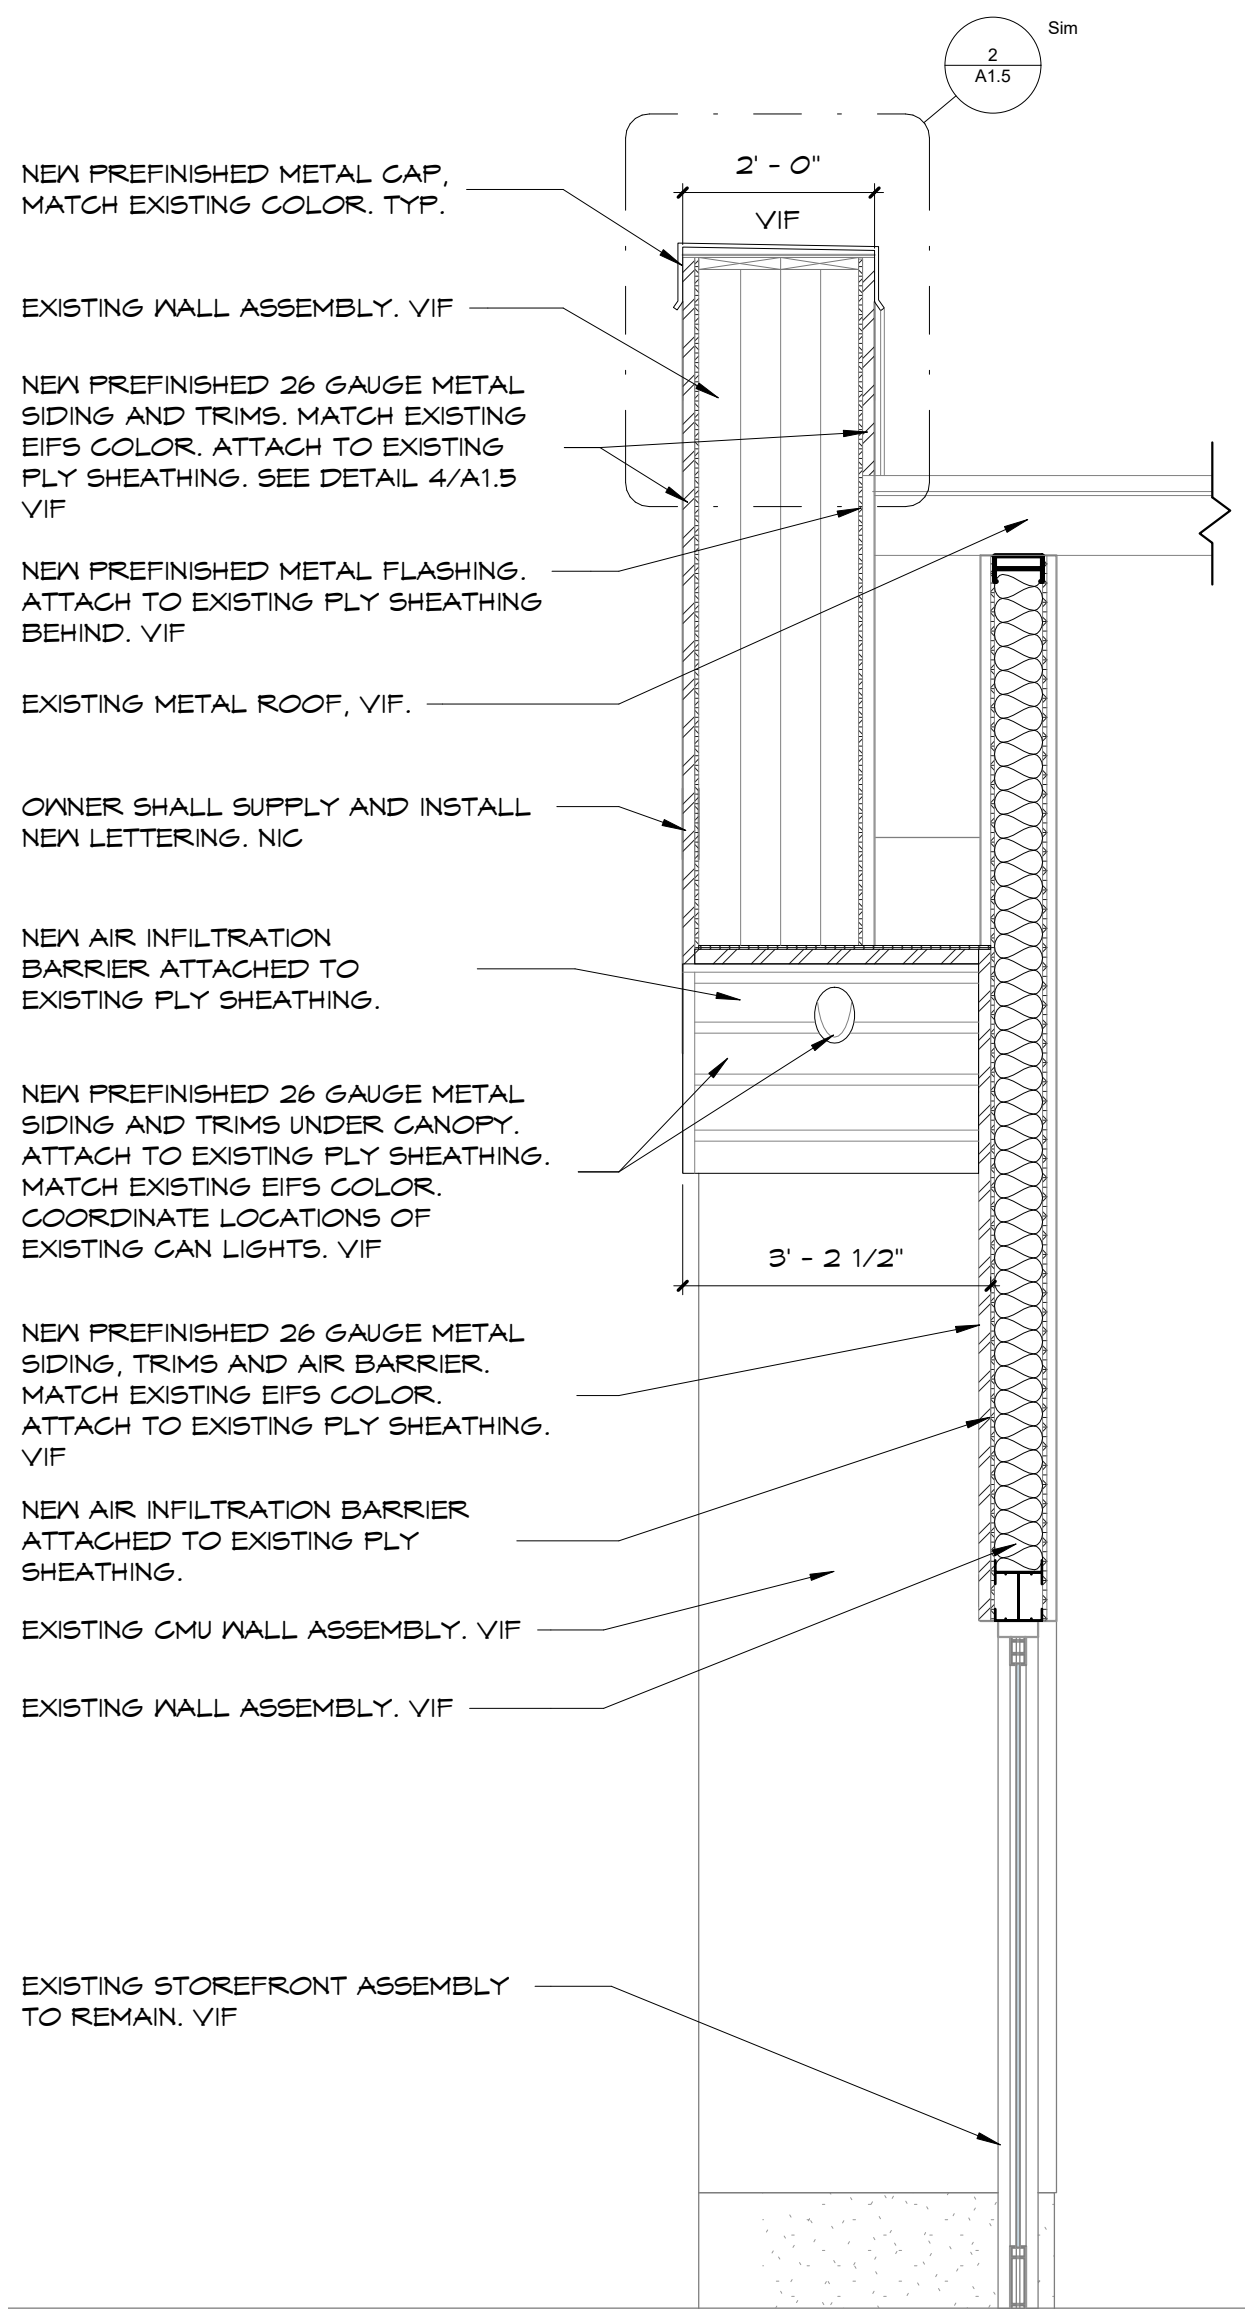
NORTH ELEVATION,
ROOF PLAN AND
SECTION

ISSUED FOR ☐ CONSTRUCTION
☒ NOT FOR CONST.


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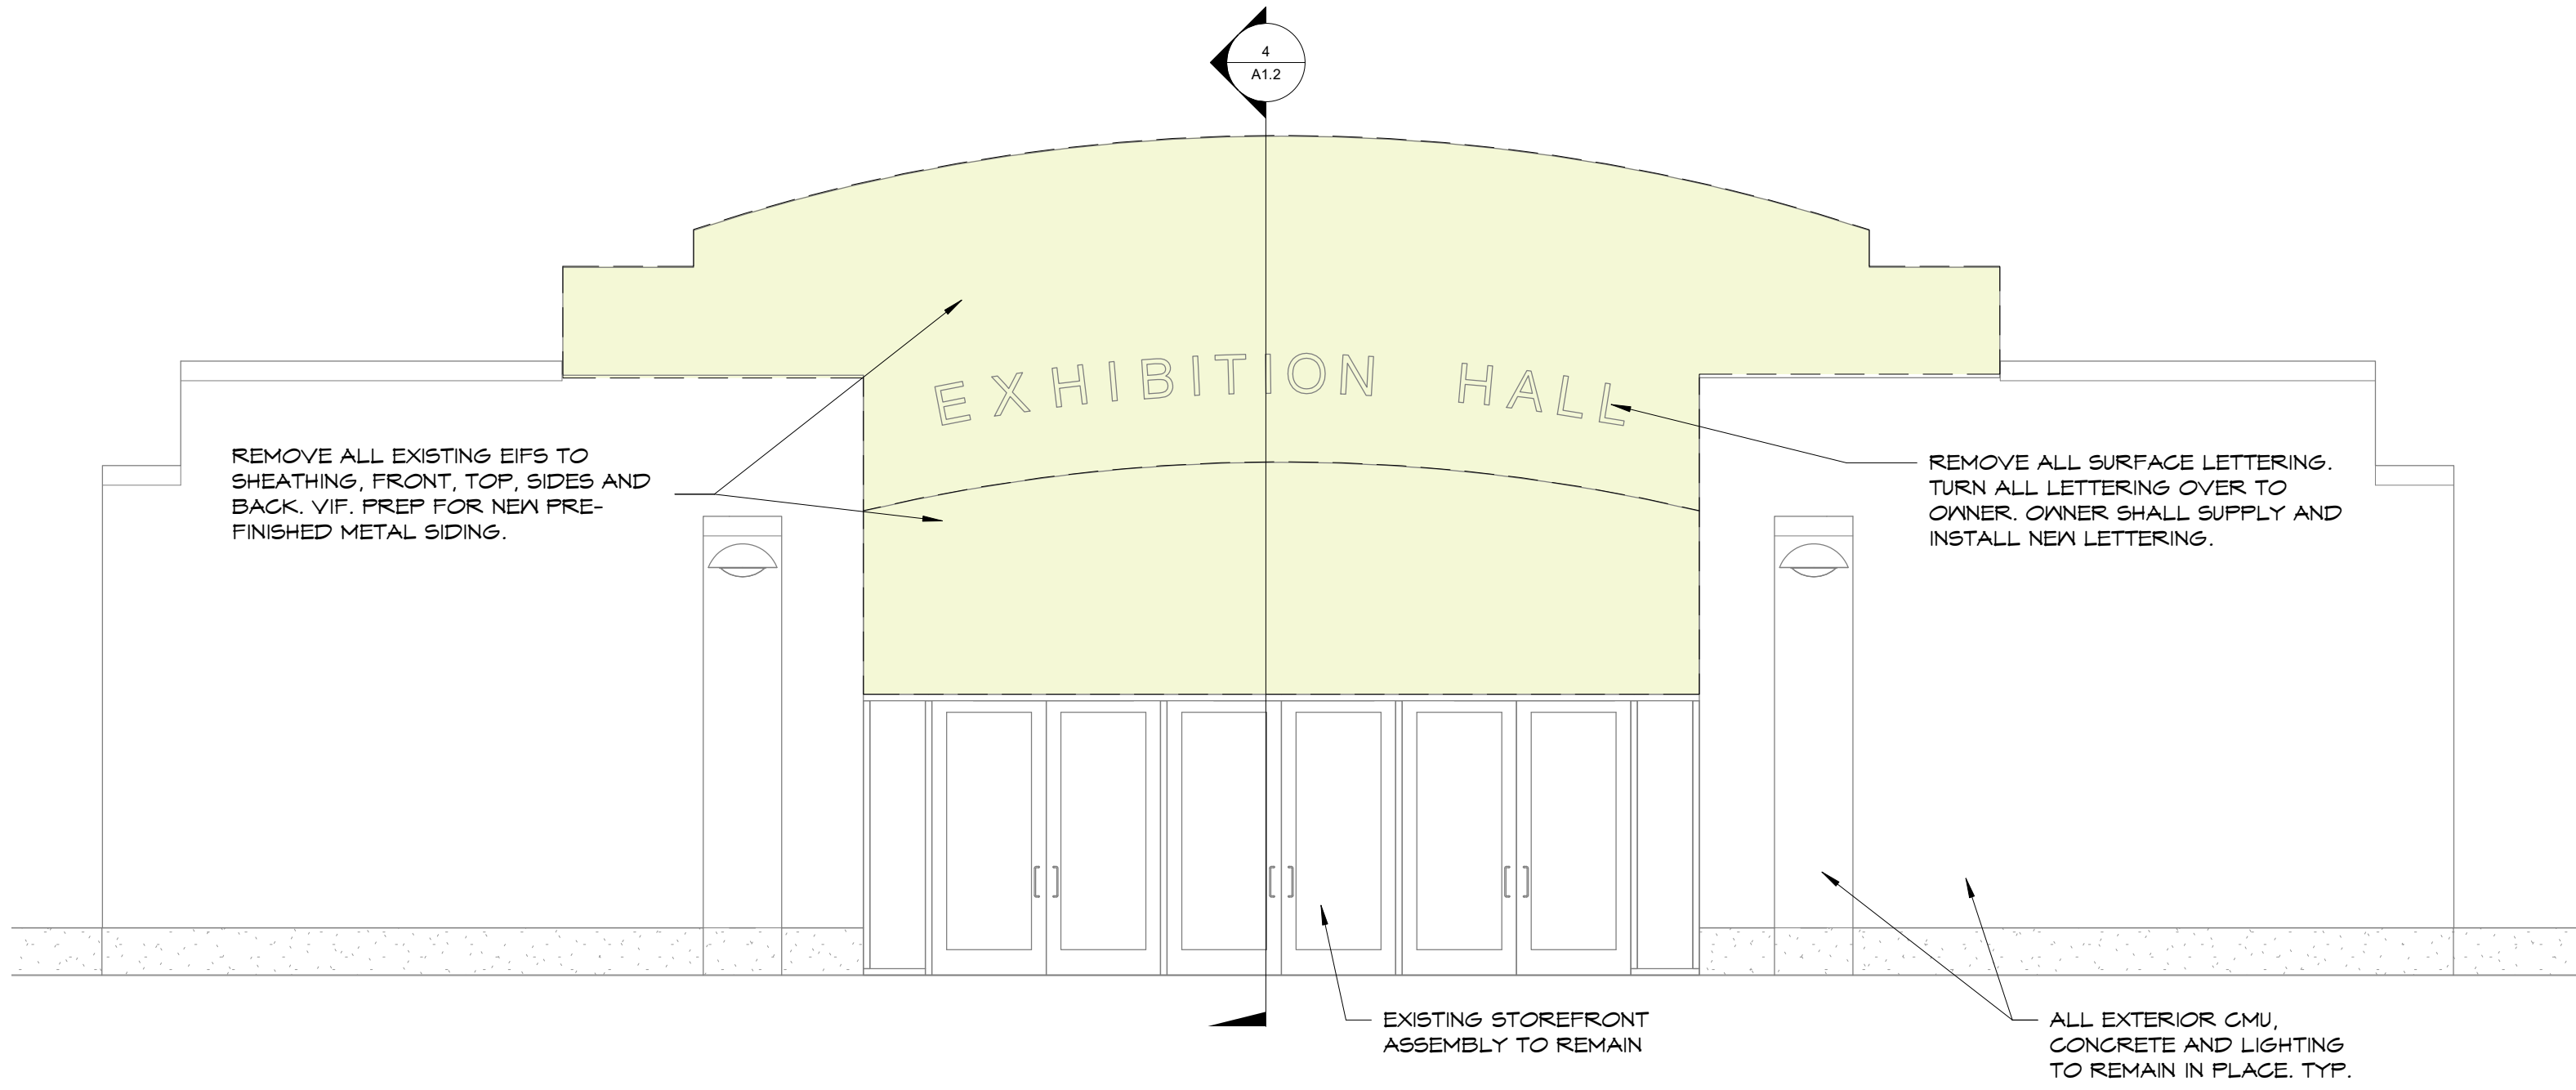
WEST ENTRANCE

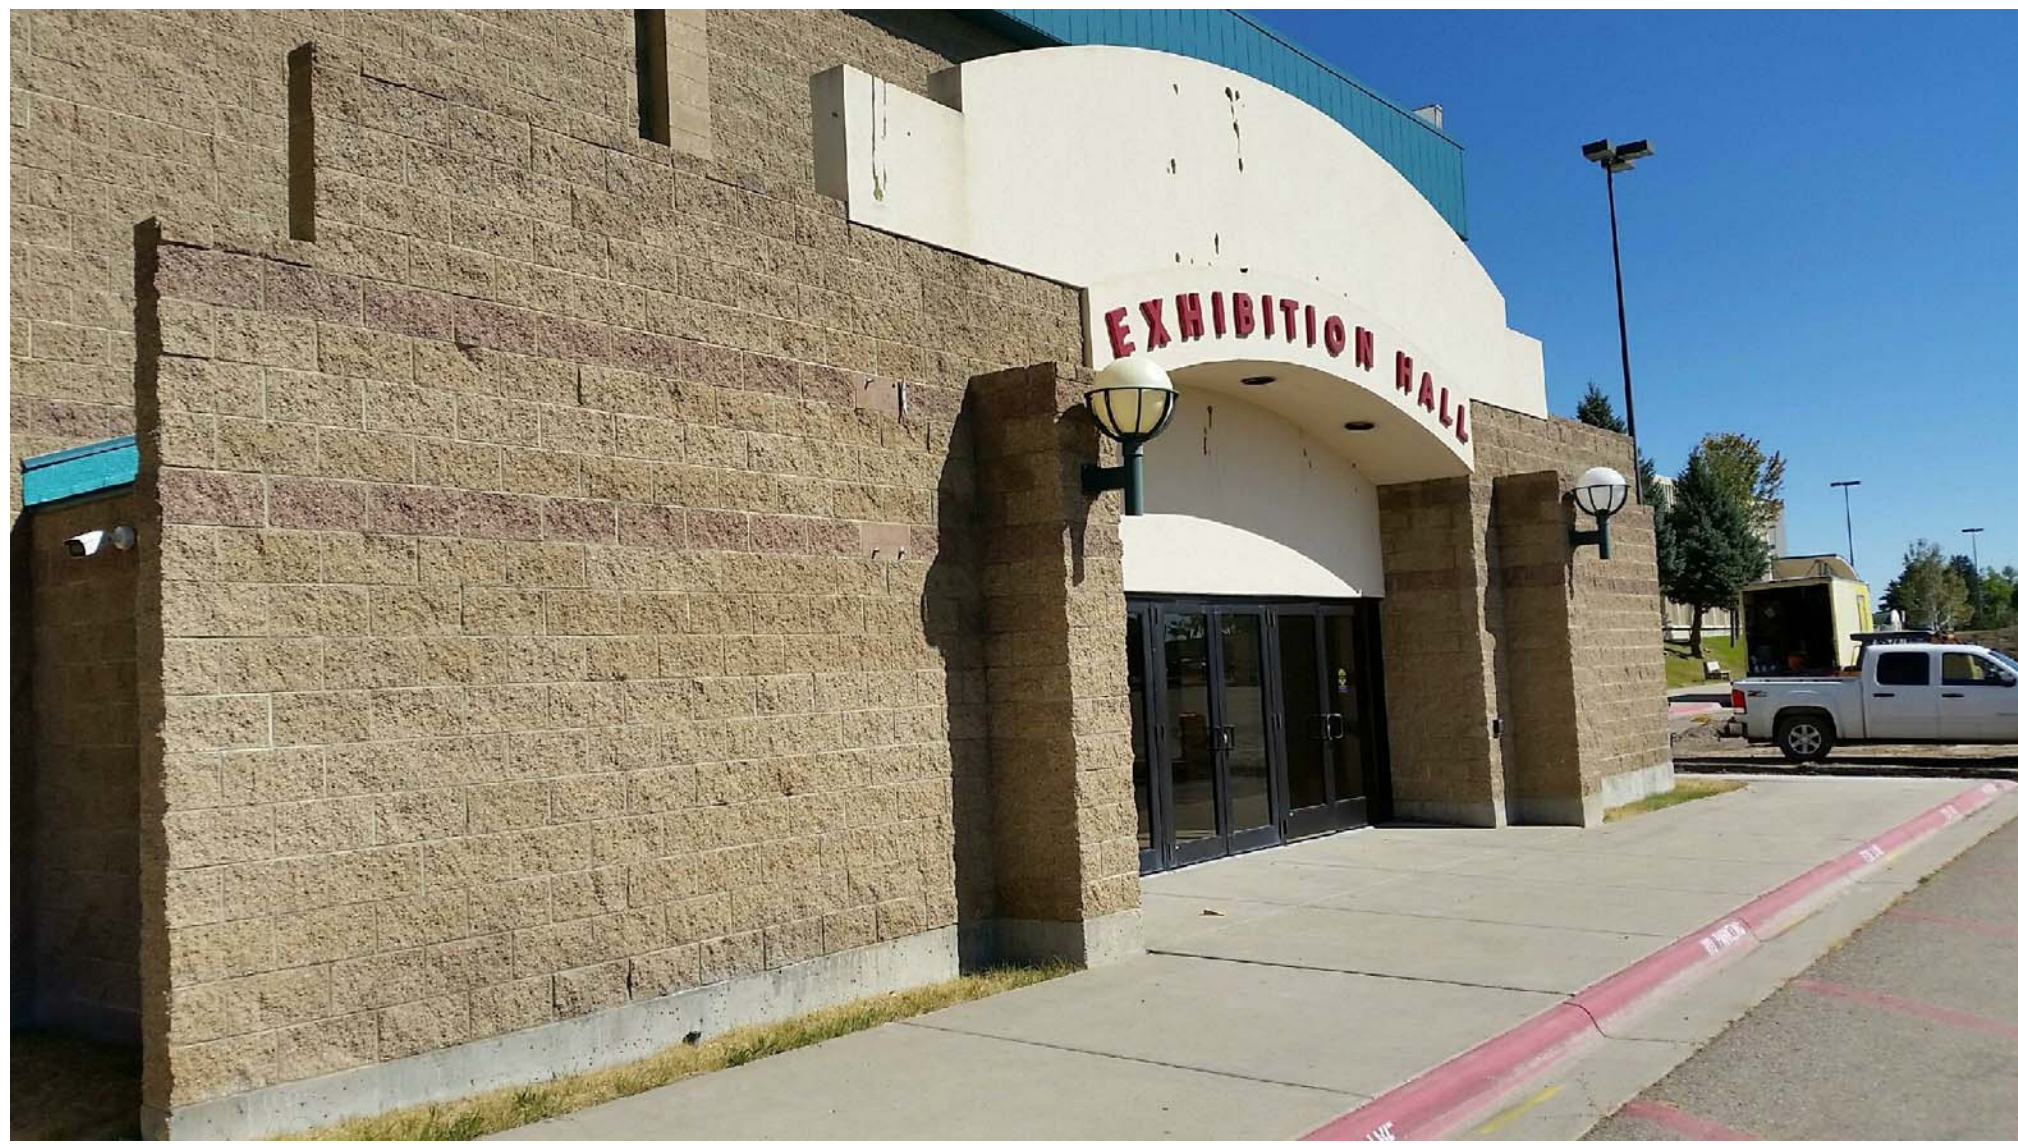


4 WEST ENTRANCE SECTION
1/2" = 1'-0"




3 ROOF PLAN - WEST ENTRANCE
1/4" = 1'-0"

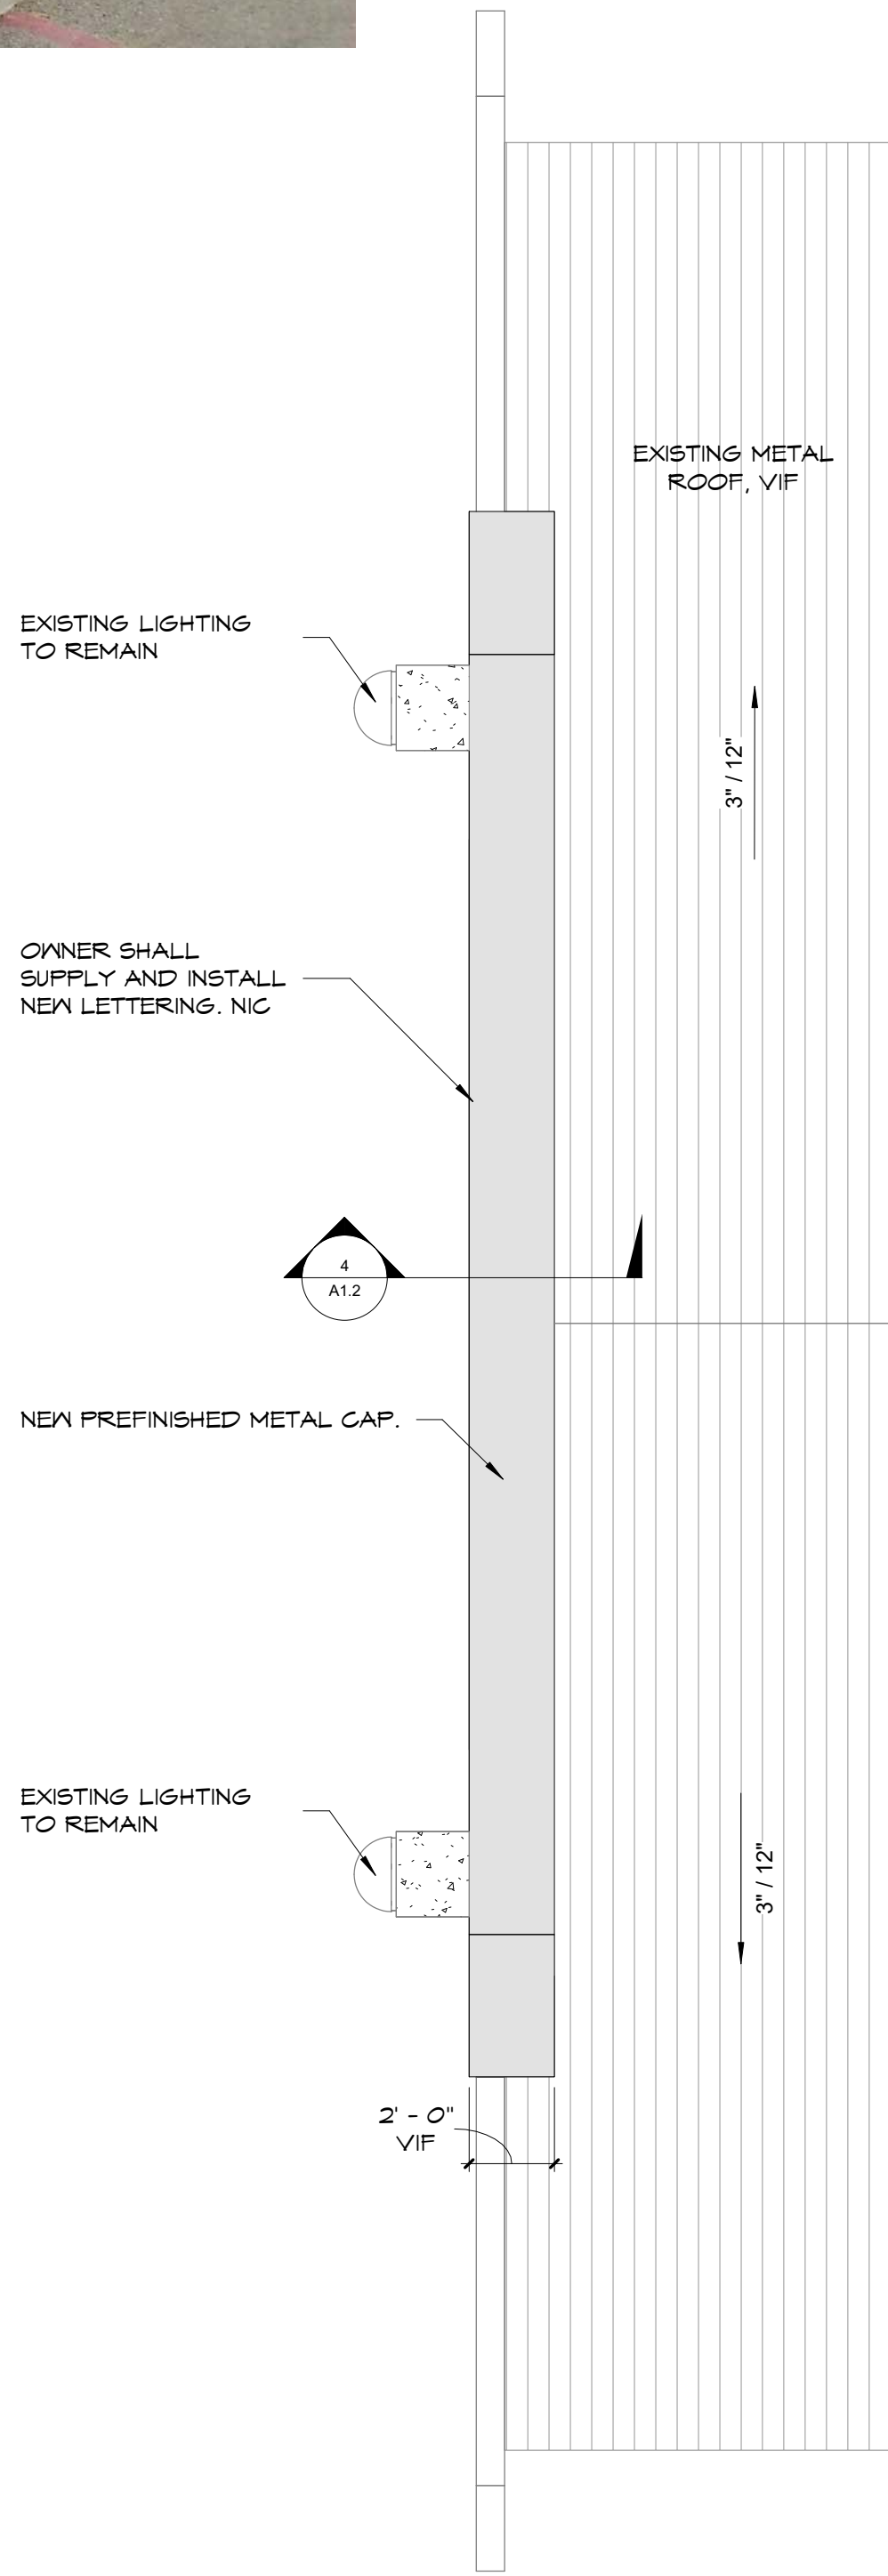

1 WEST ENTRANCE ELEVATION - DEMOLITION
1/4" = 1'-0"



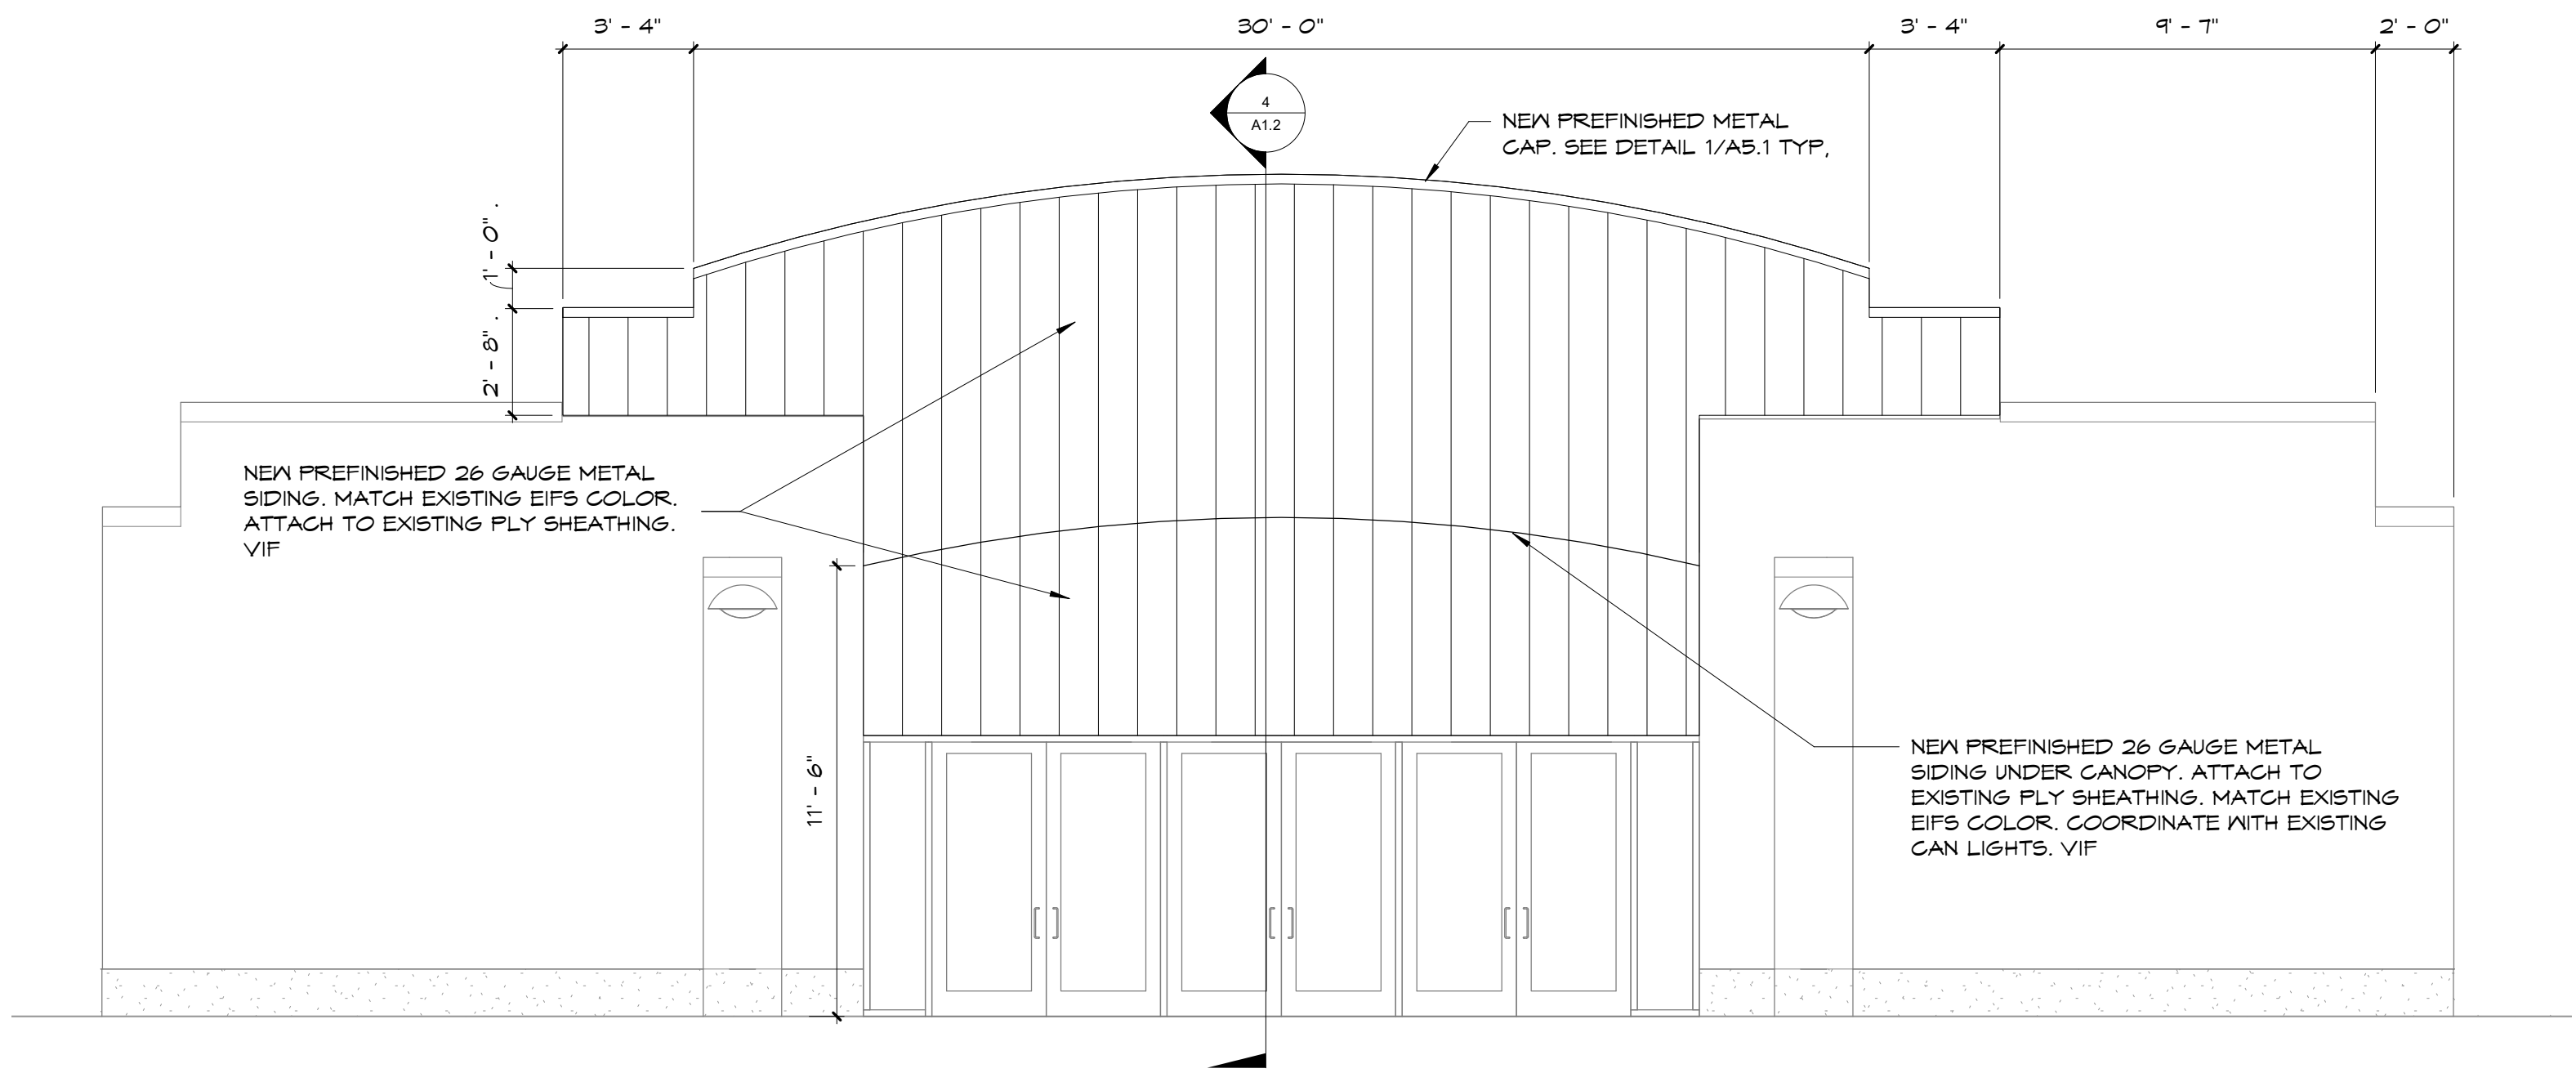


2 WEST ENTRANCE ELEVATION - NEW METAL SIDING
1/4" = 1'-0"


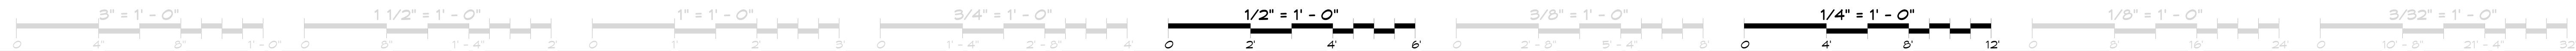


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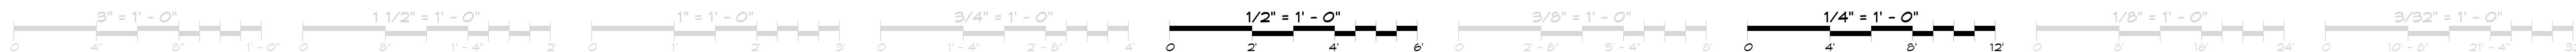
SOUTHWEST ENTRANCE

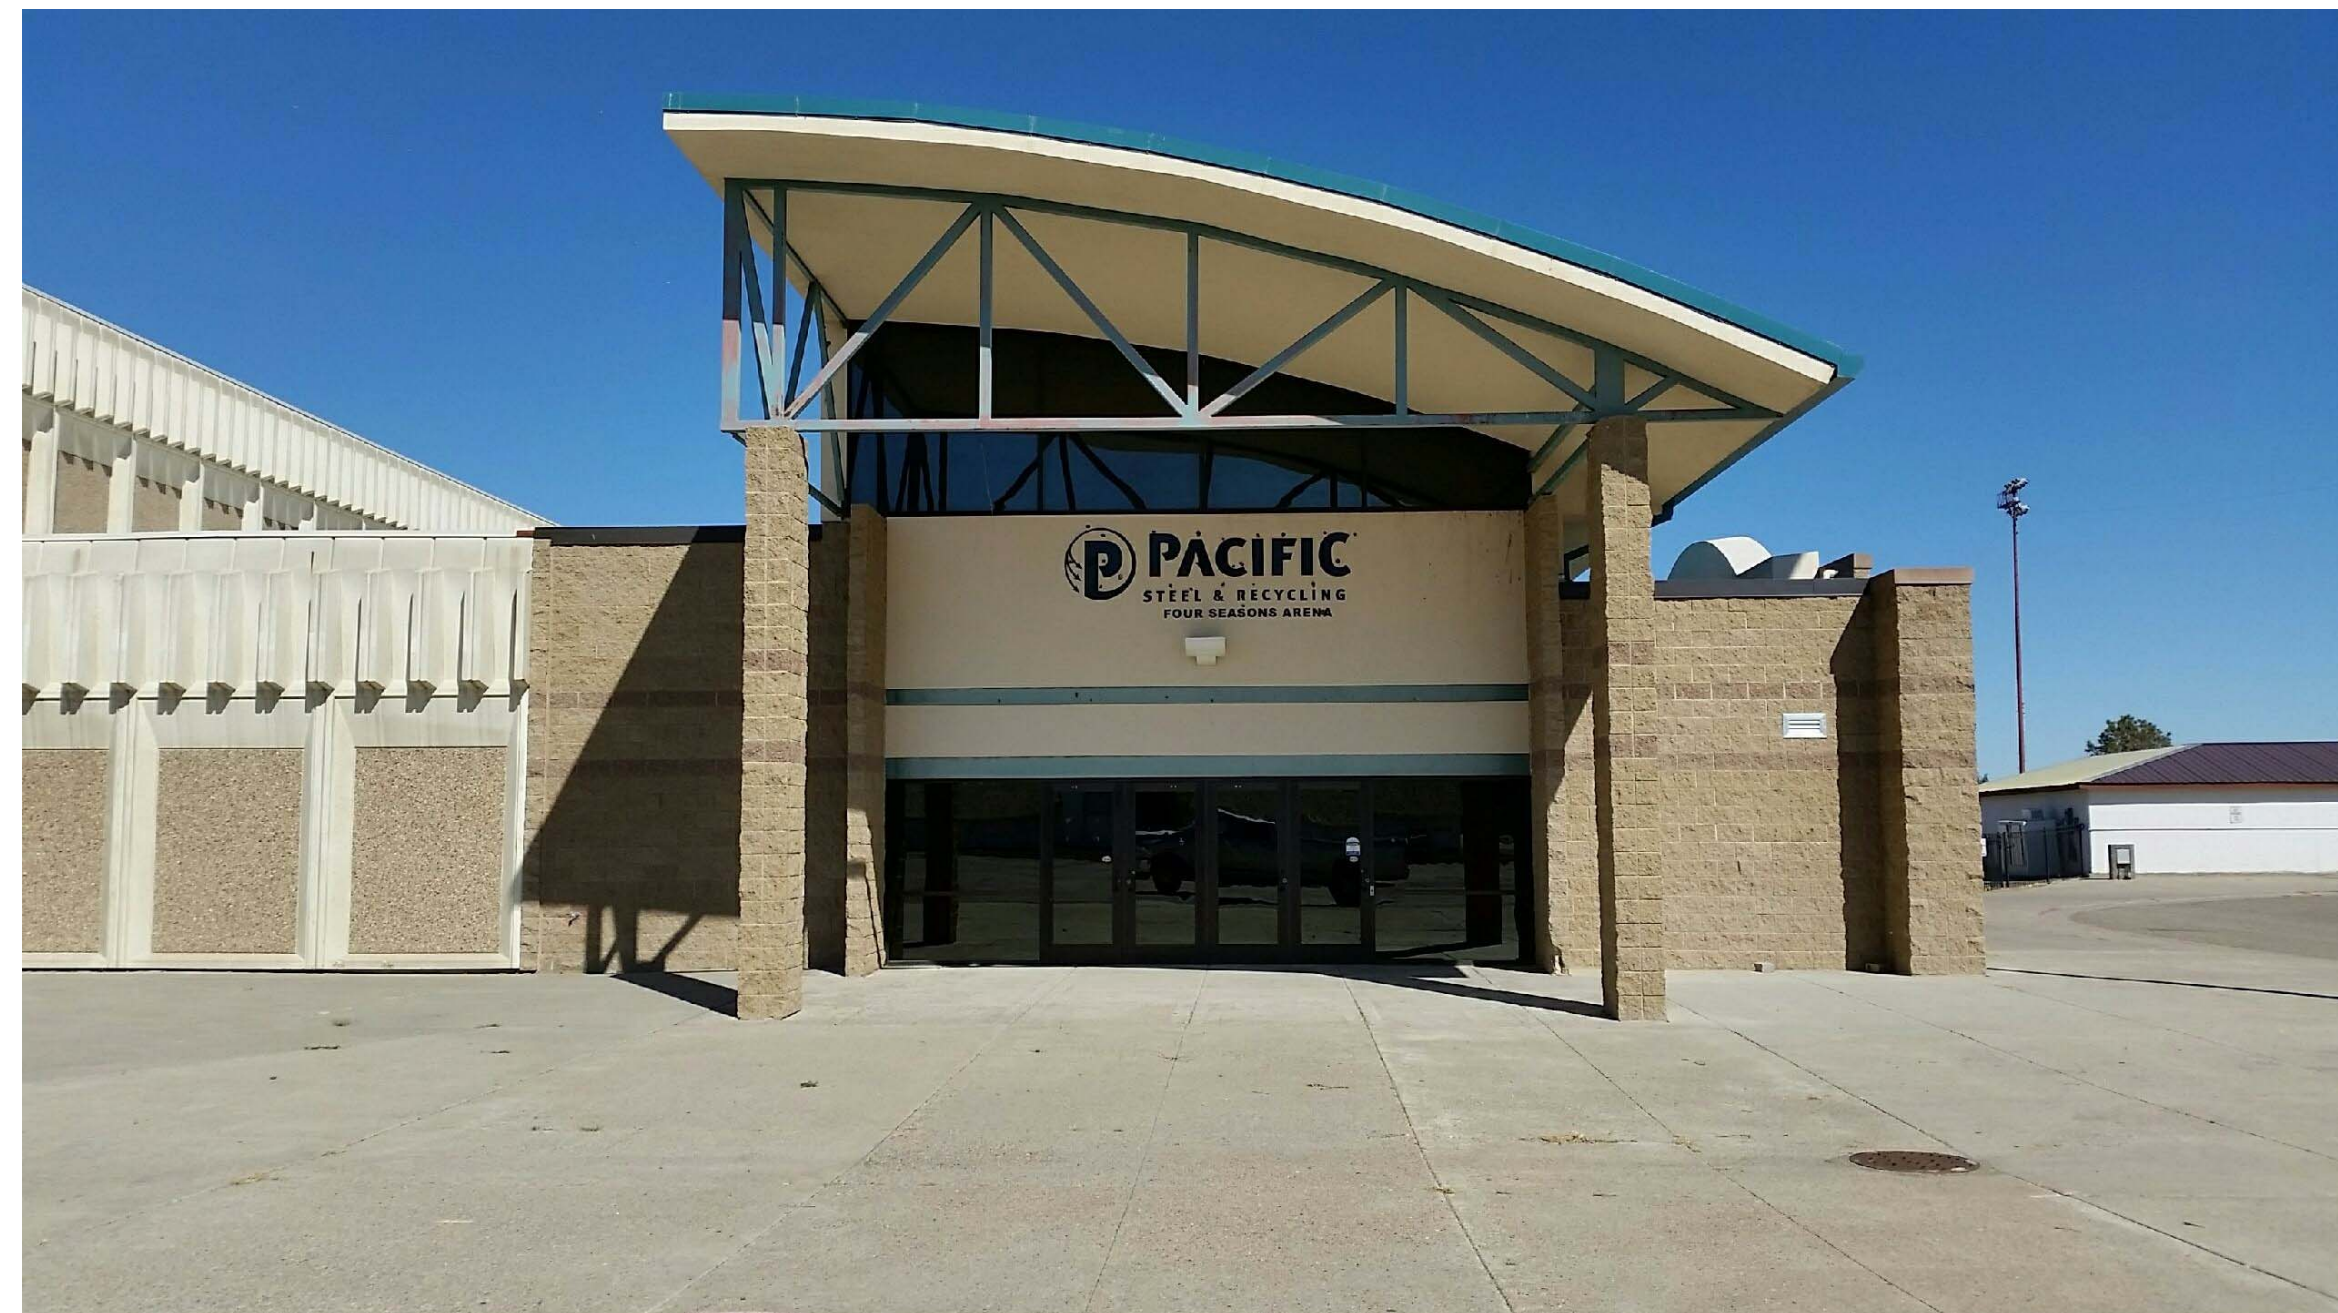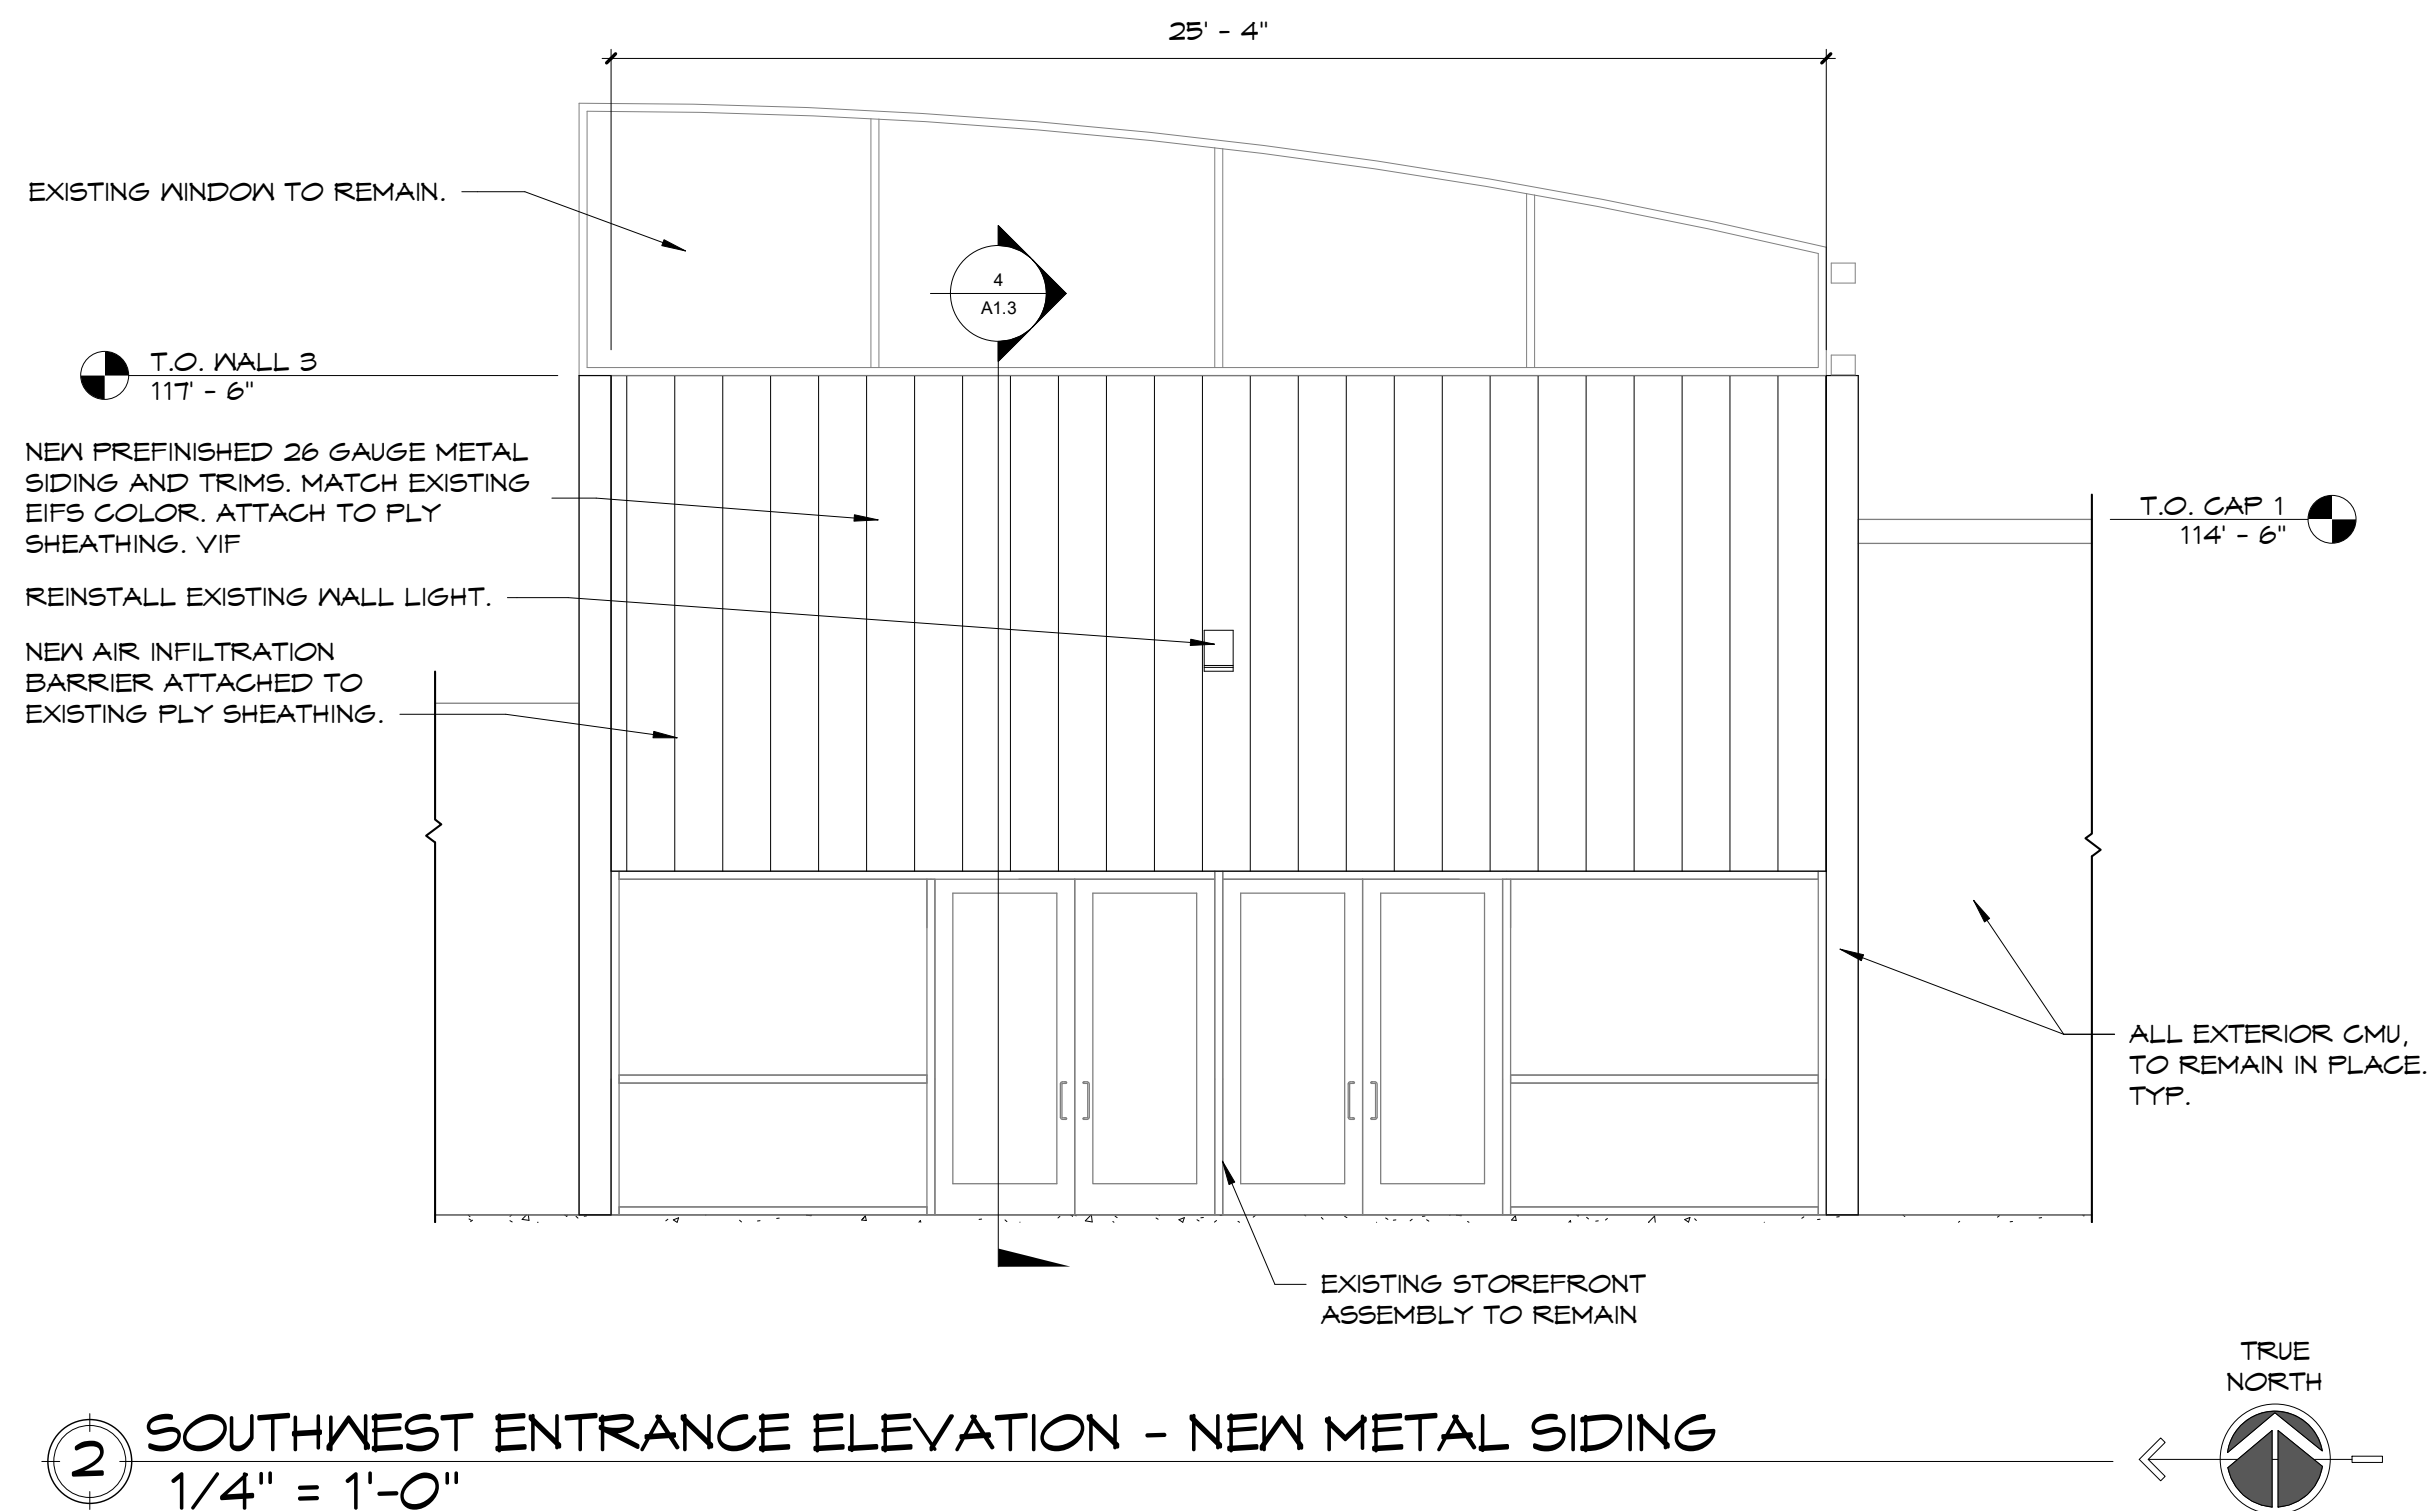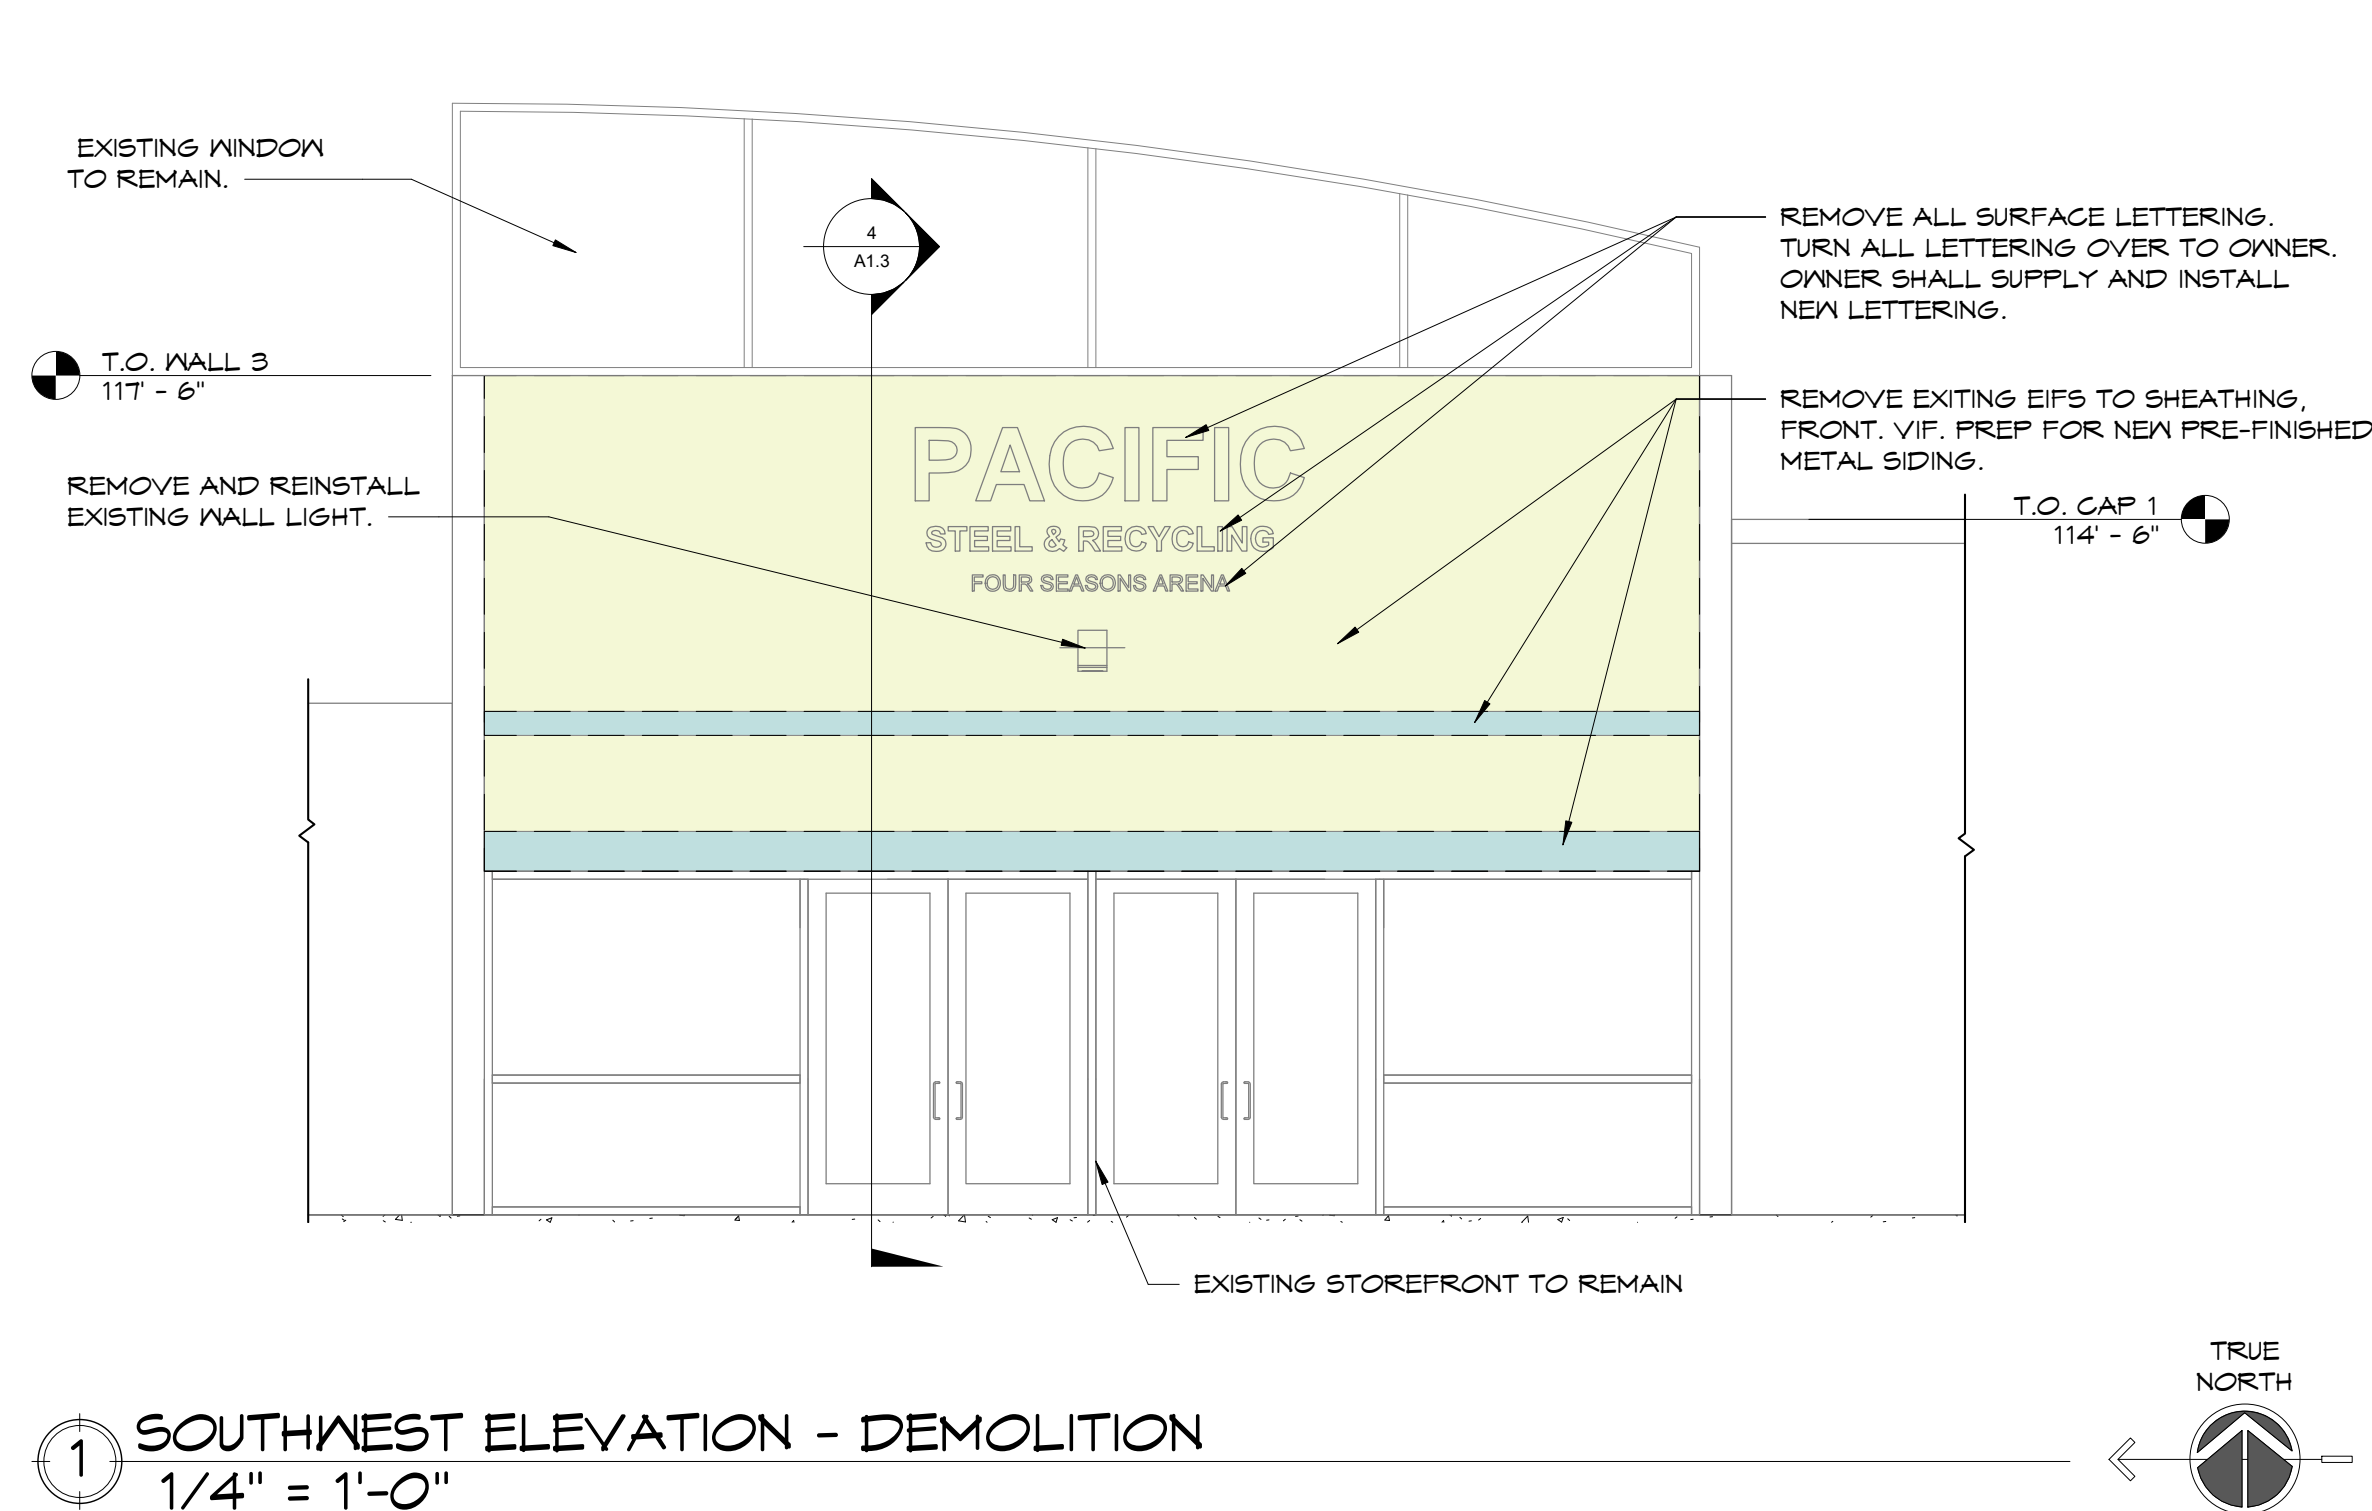

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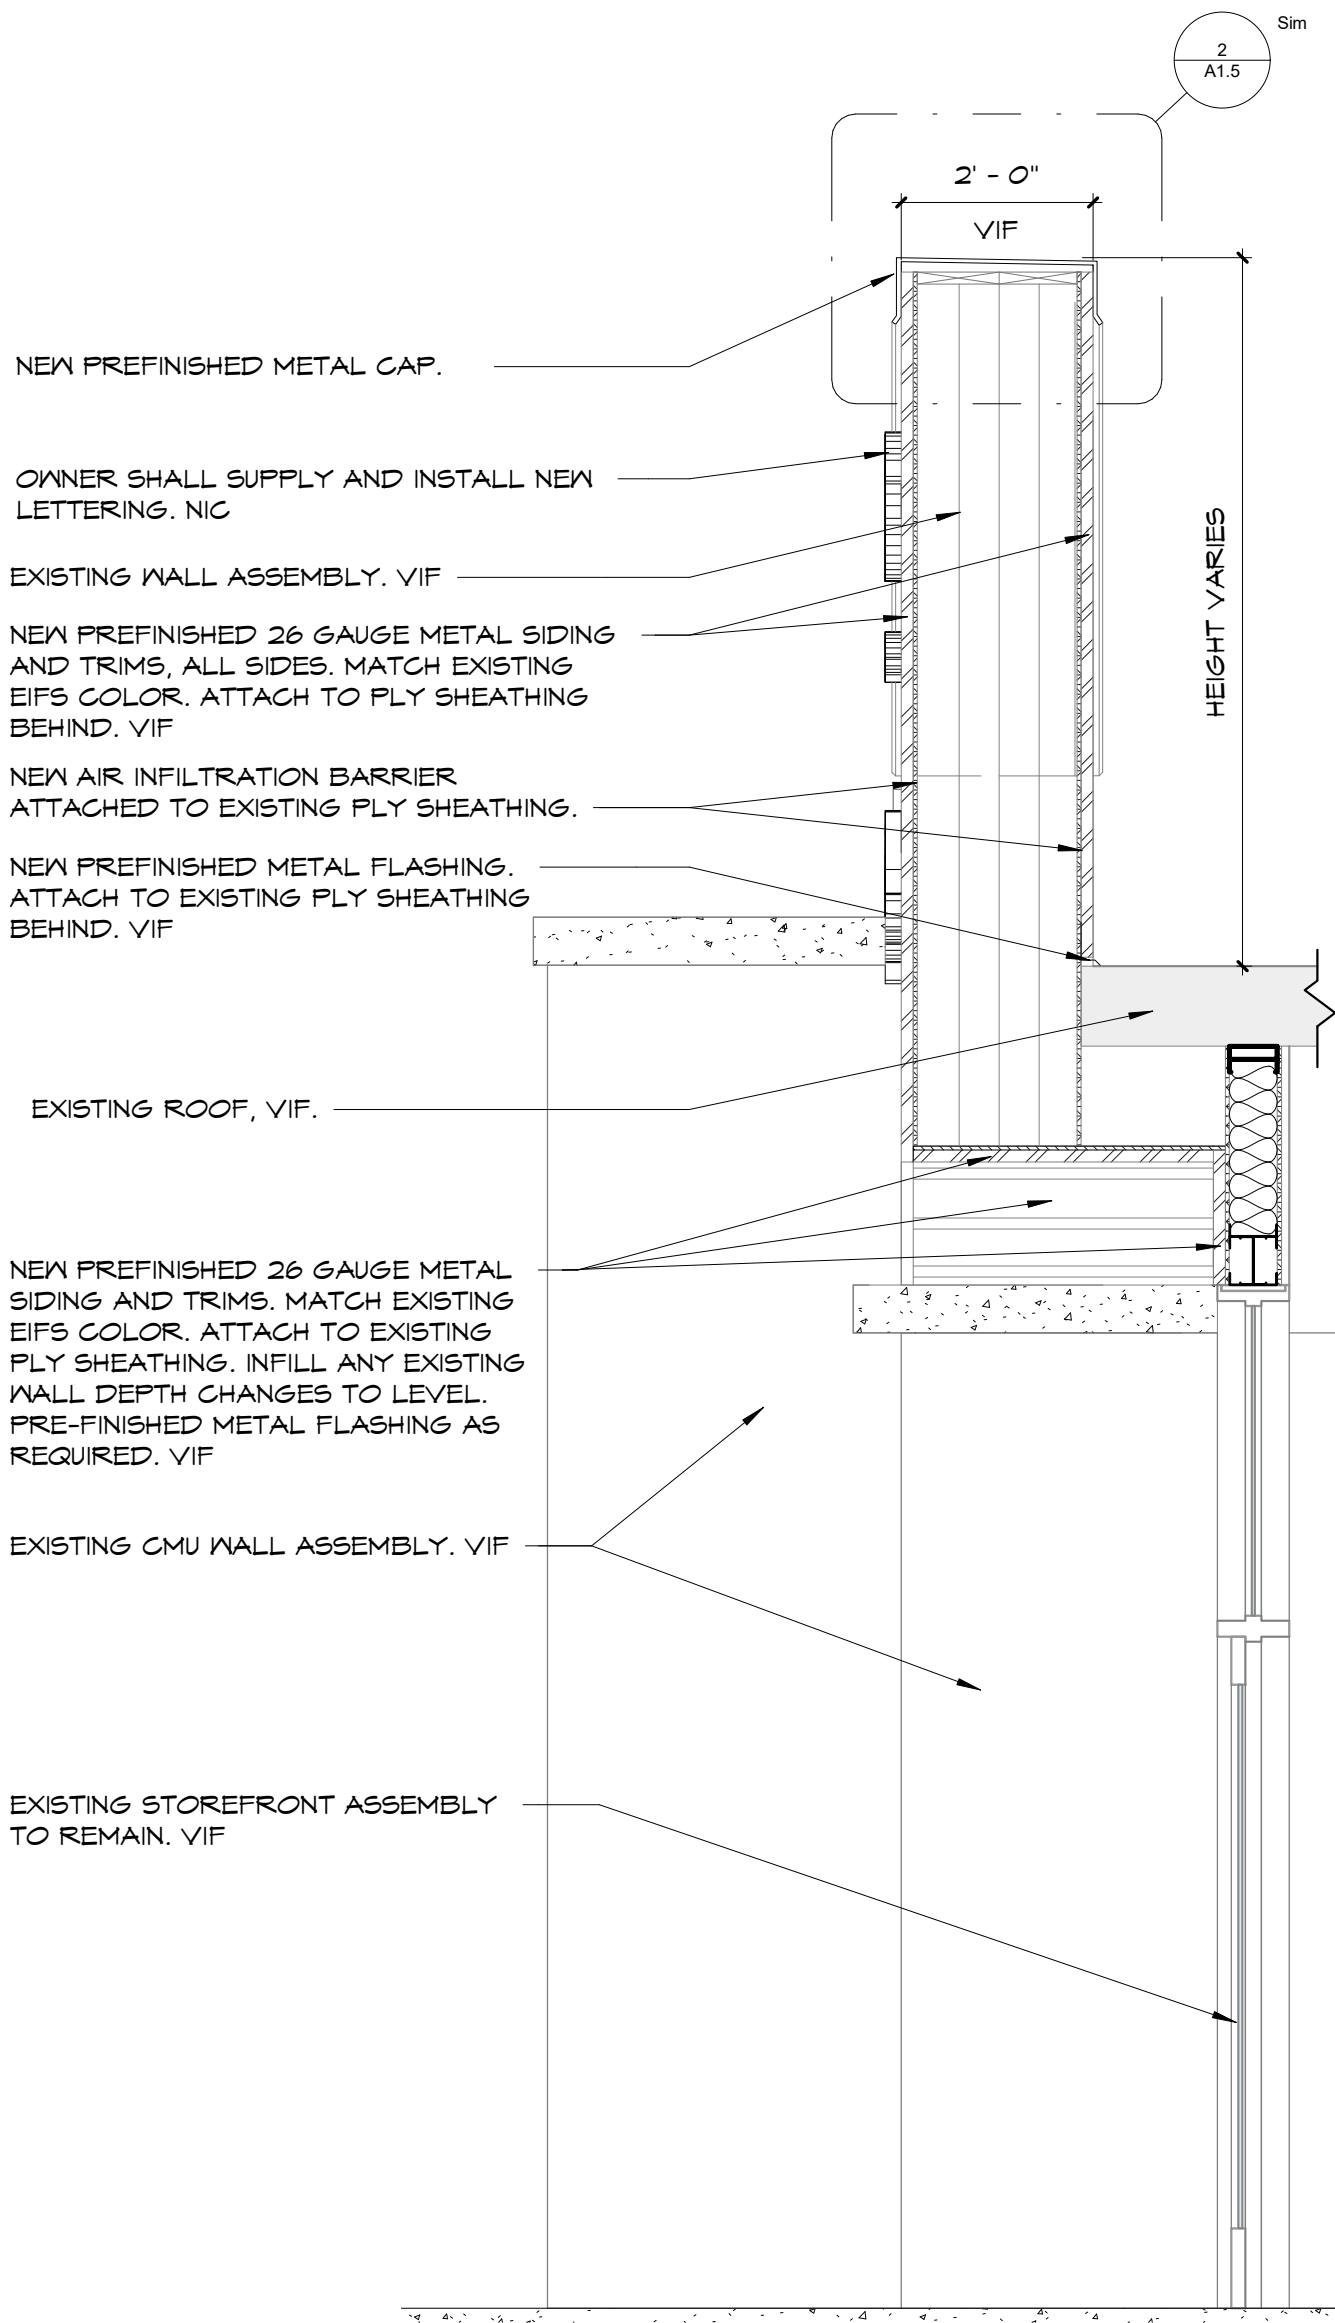
SOUTHWEST ENTRANCE - ELEVATIONS, ROOF PLAN AND SECTION	ISSUED FOR	<input type="checkbox"/> CONSTRUCTION
	NOT FOR CONST.	<input checked="" type="checkbox"/>

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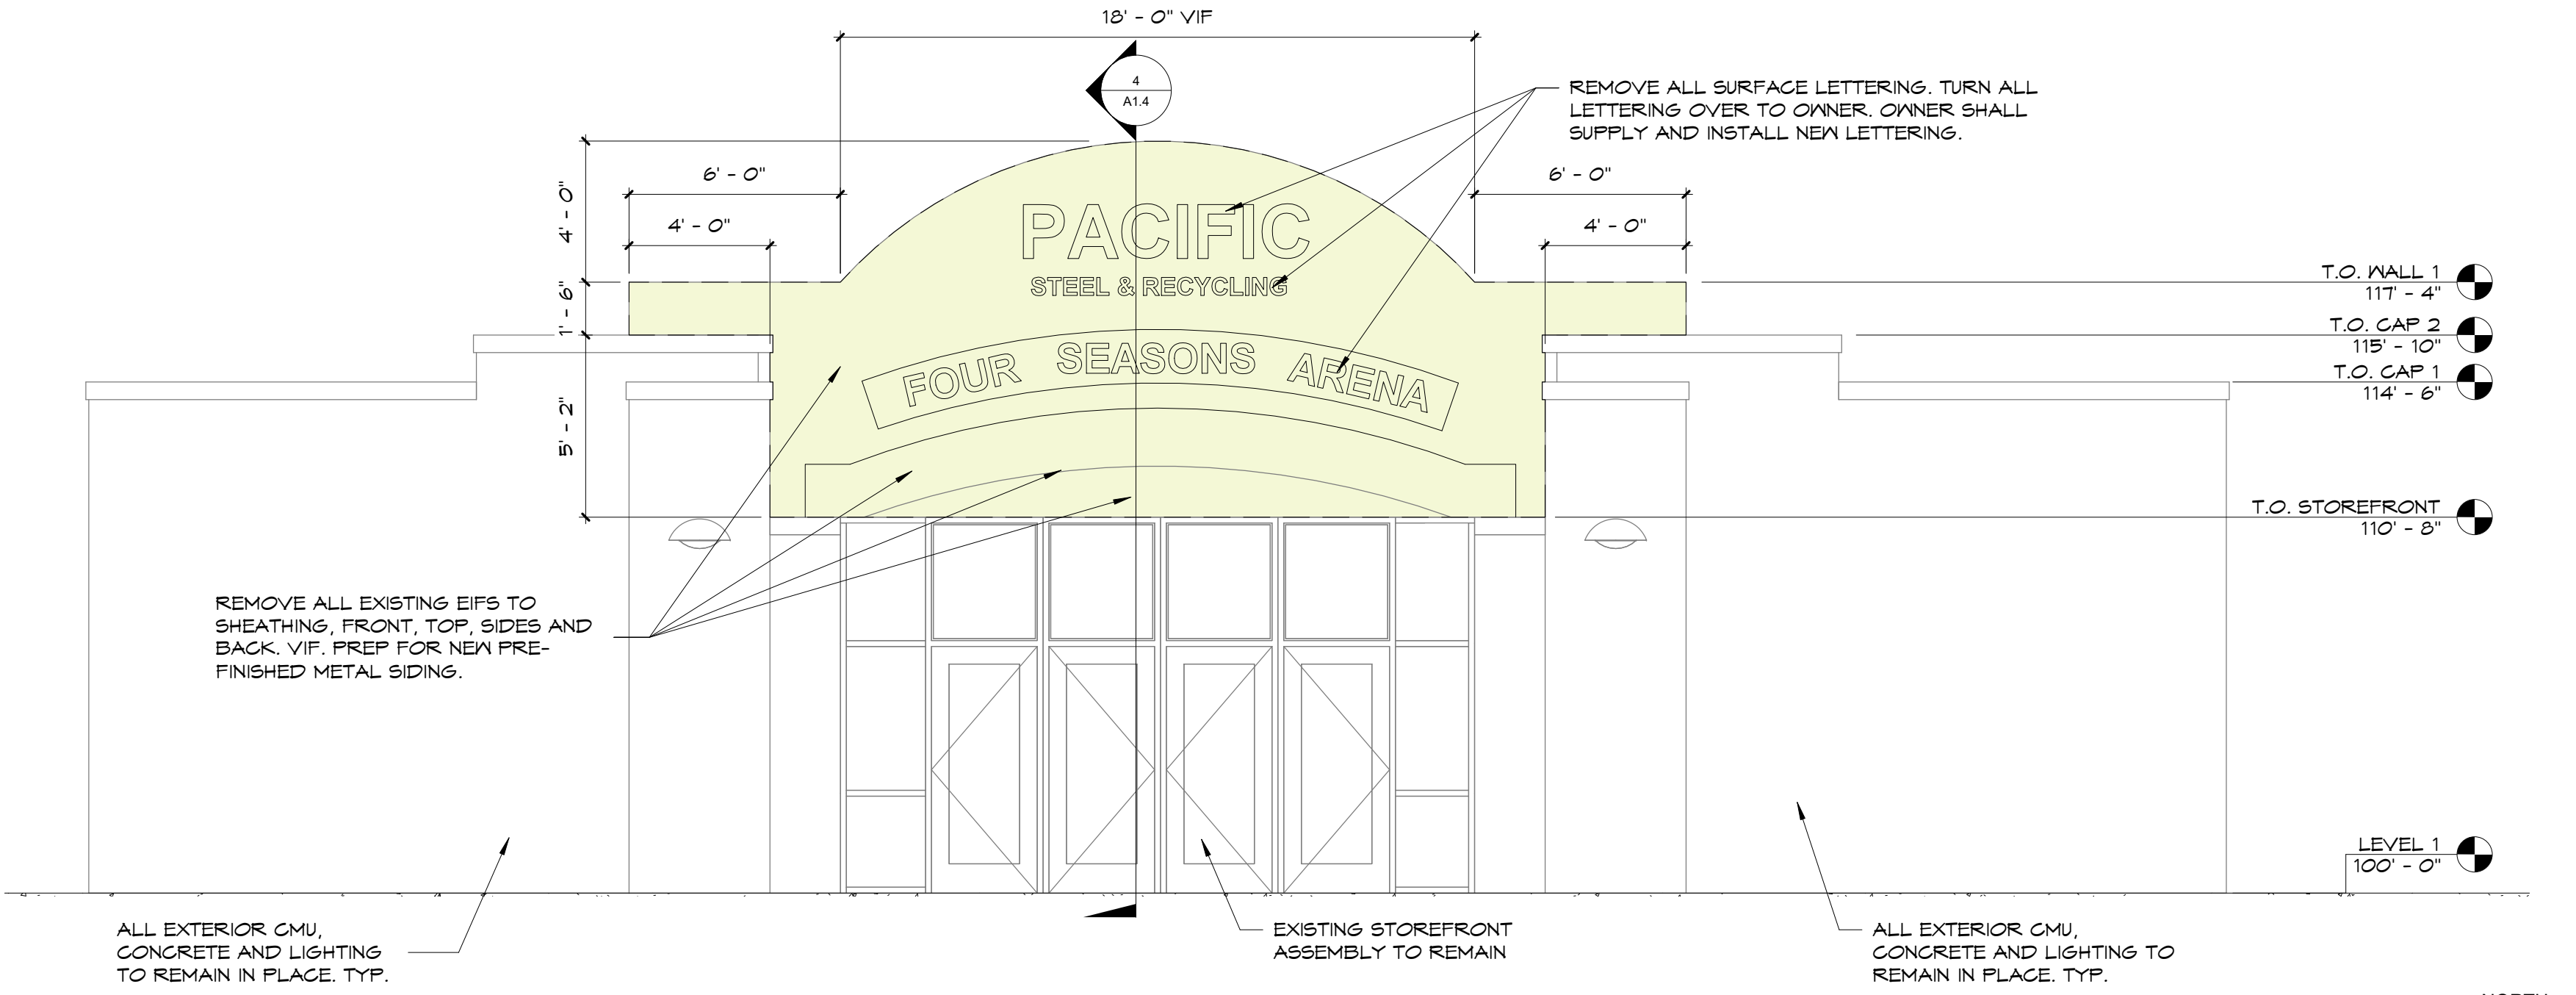


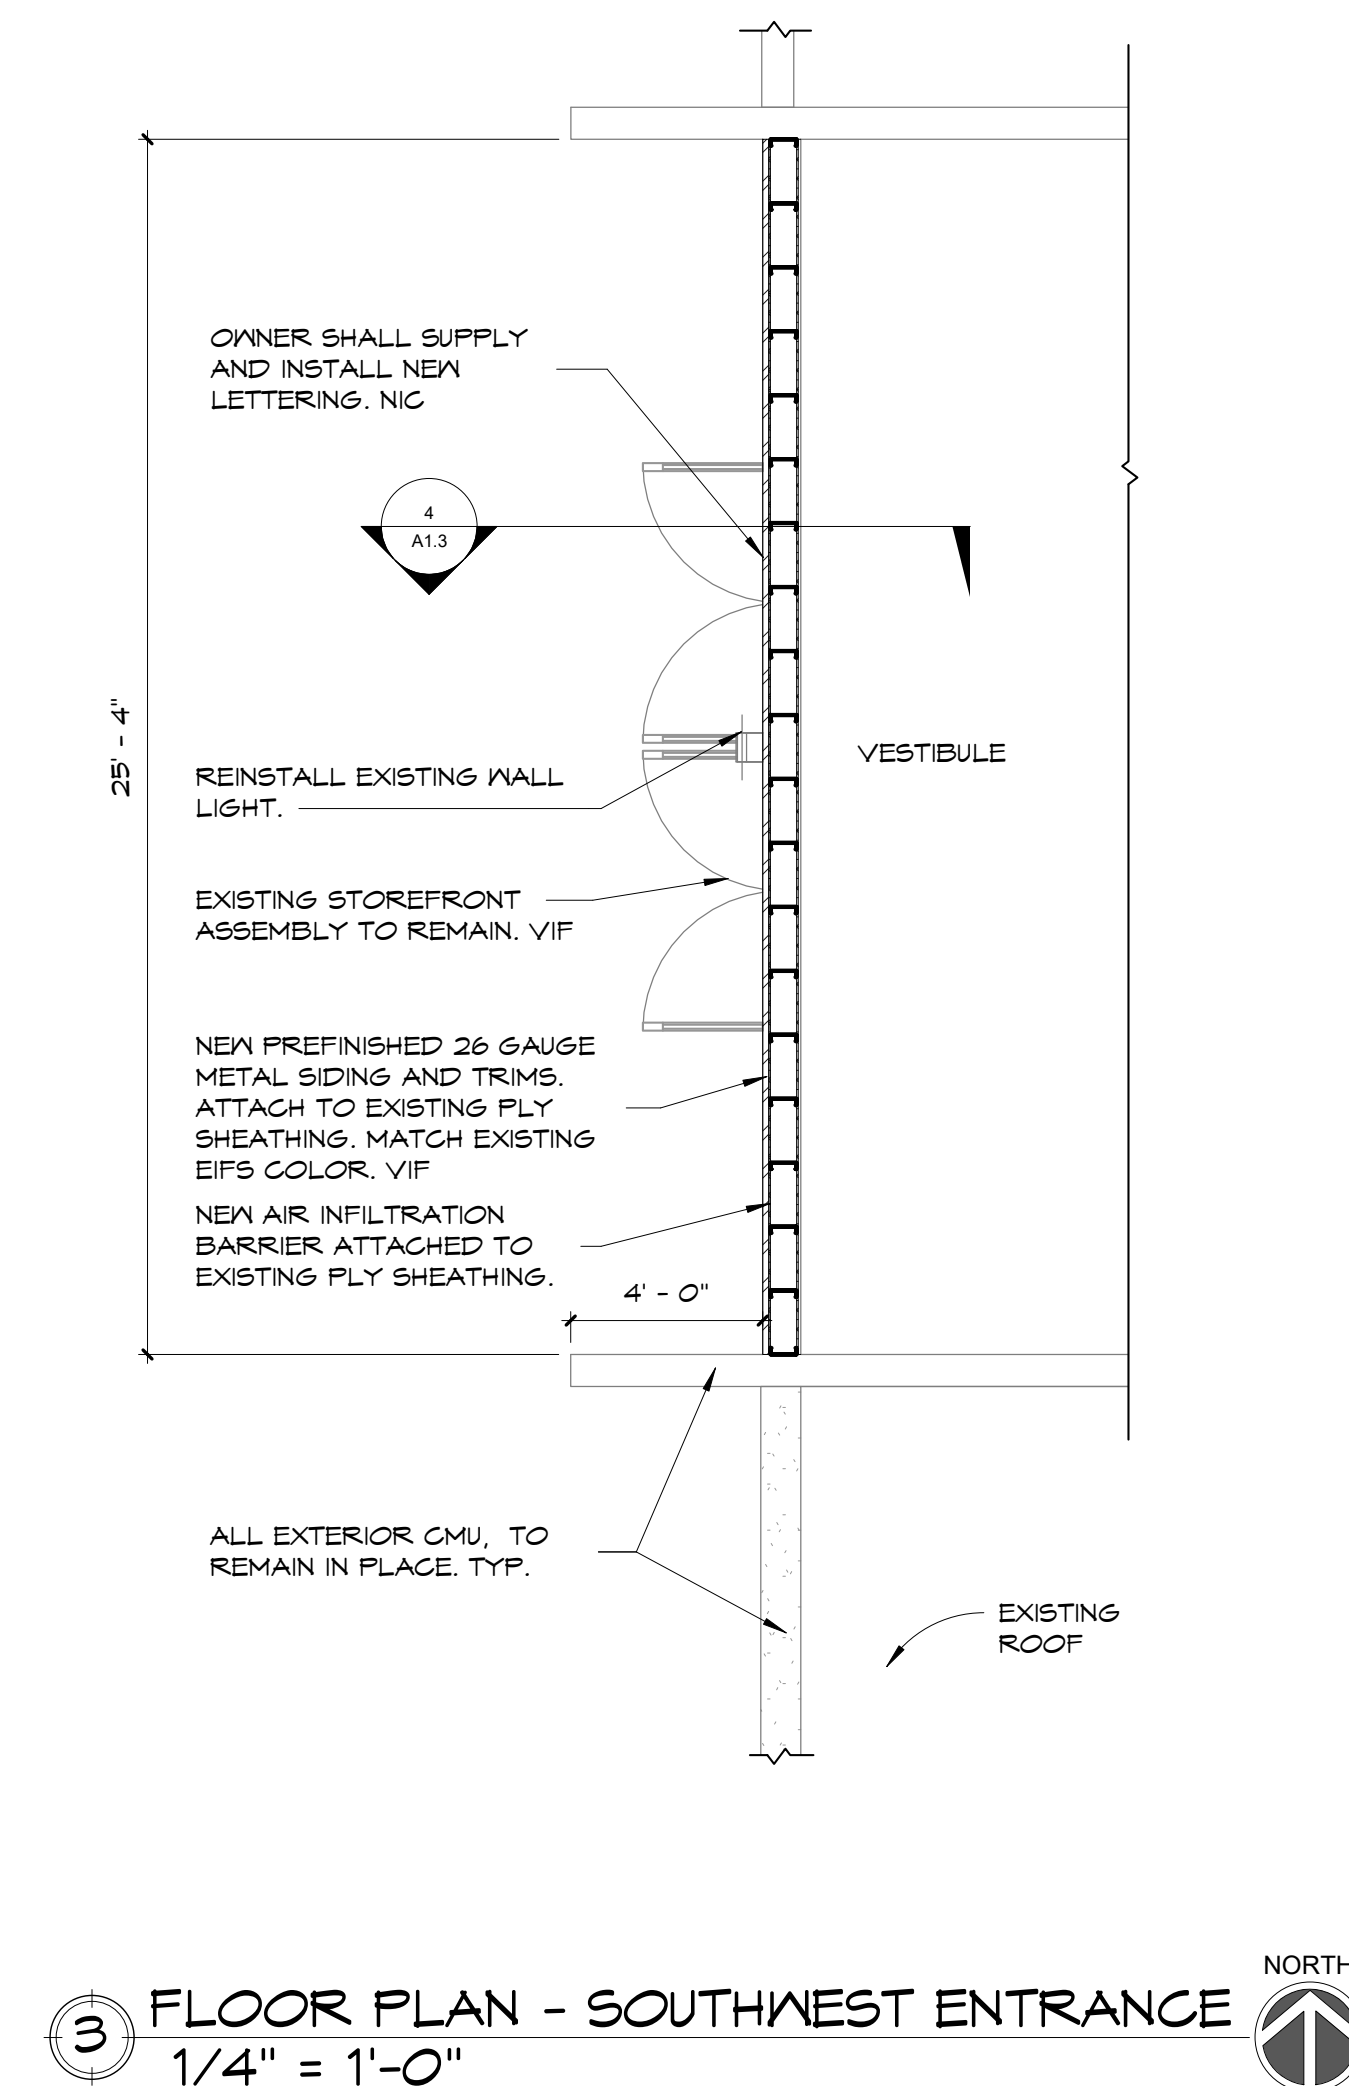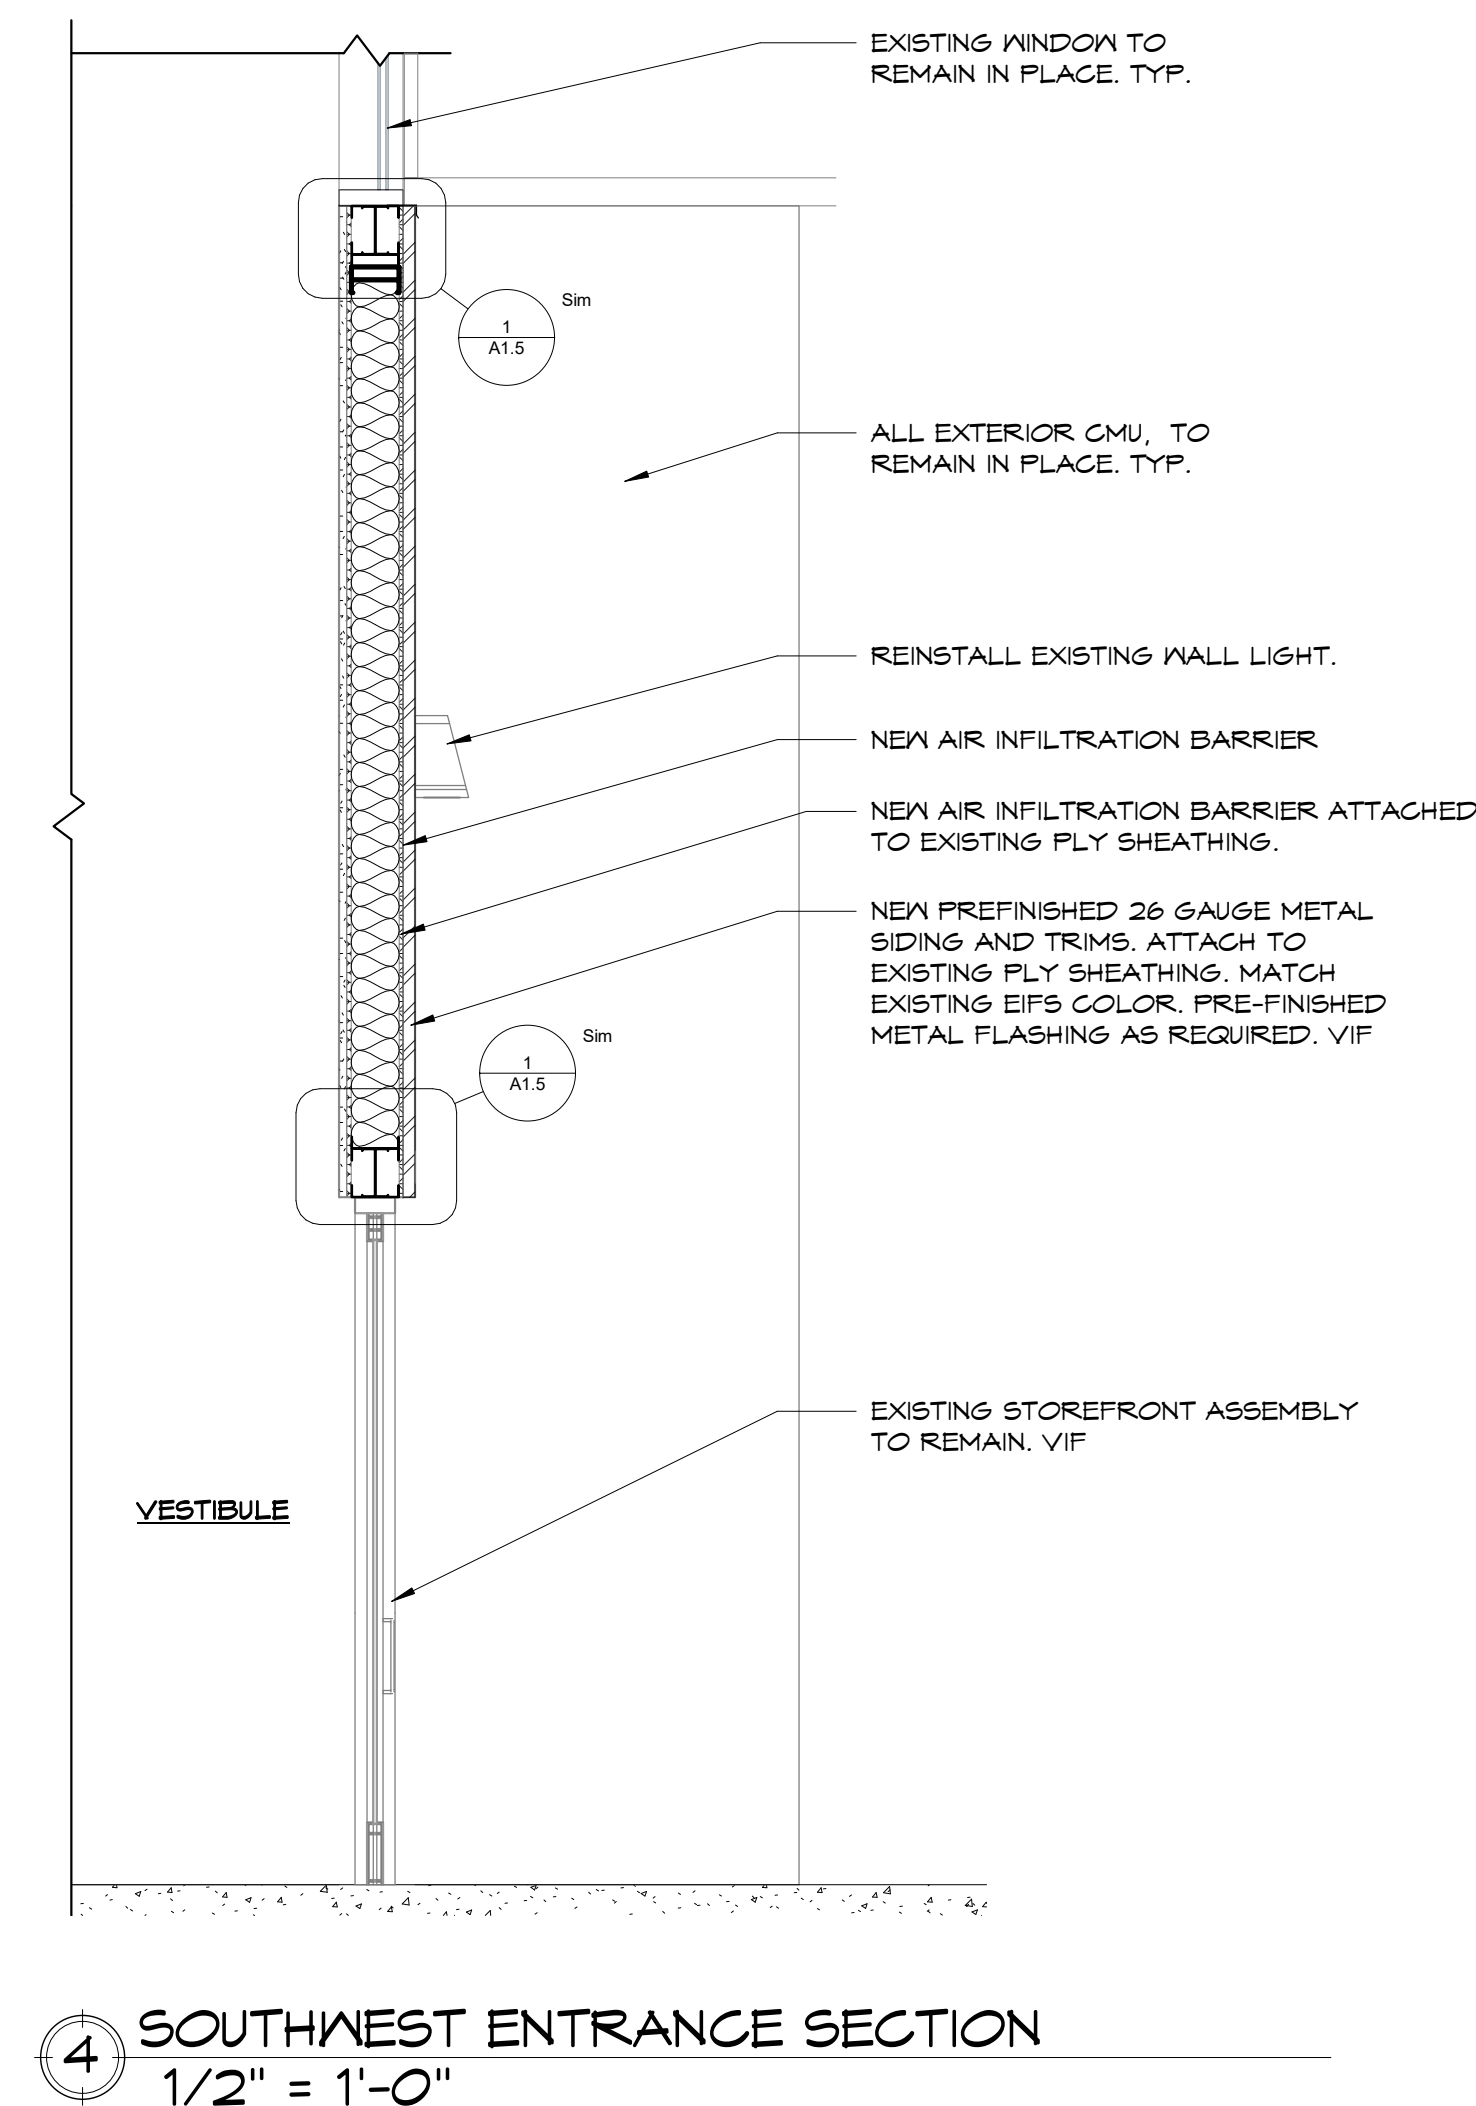


SOUTH ENTRANCE




4 SOUTH ENTRANCE SECTION
1/2" = 1'-0"




1 SOUTH ENTRANCE ELEVATION - DEMOLITION
1/4" = 1'-0"

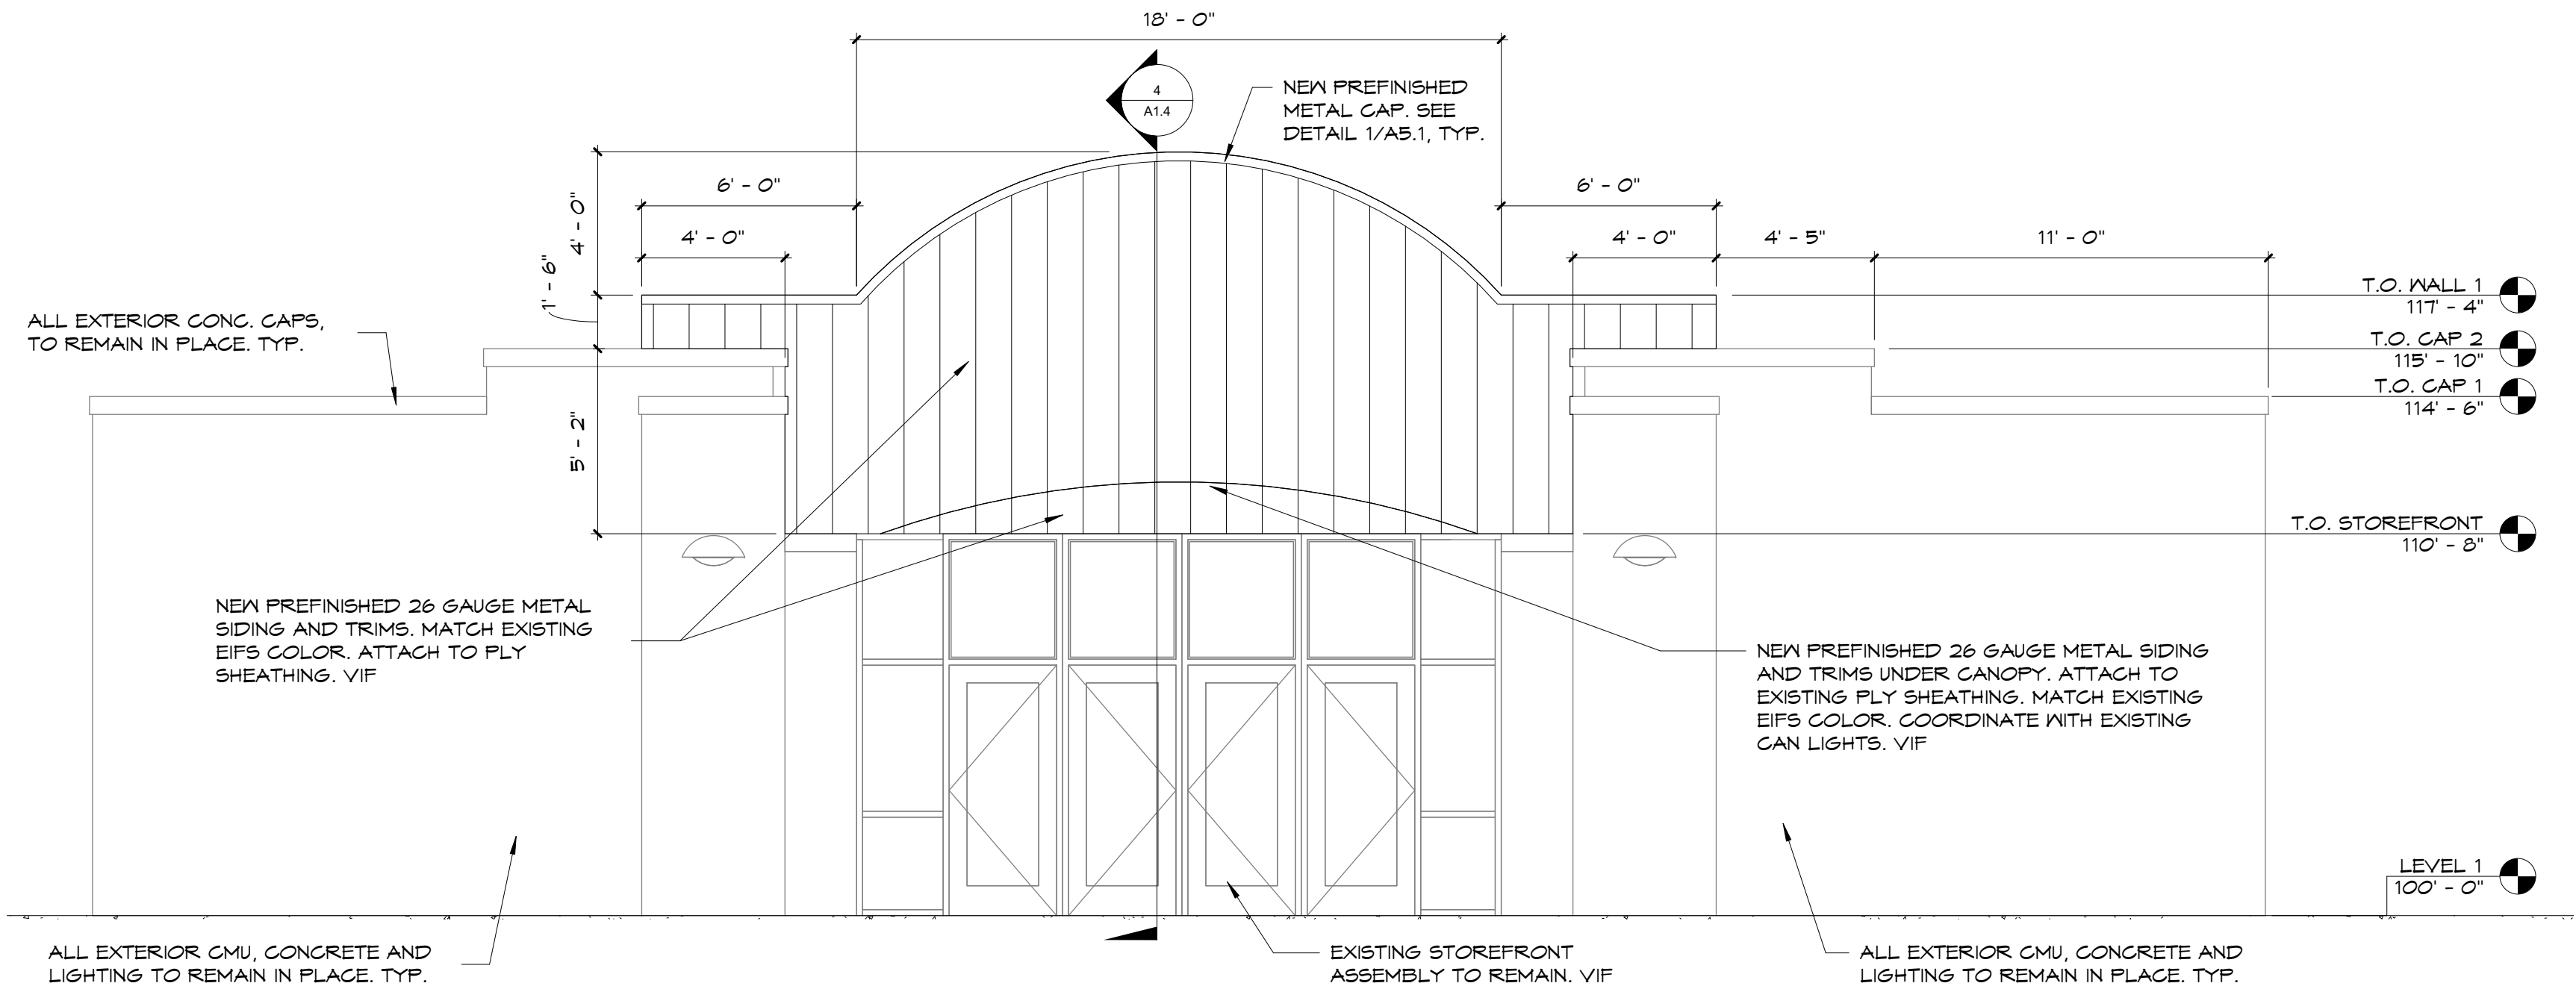


2 SOUTH ENTRANCE ELEVATION - NEW METAL SIDING
1/4" = 1'-0"

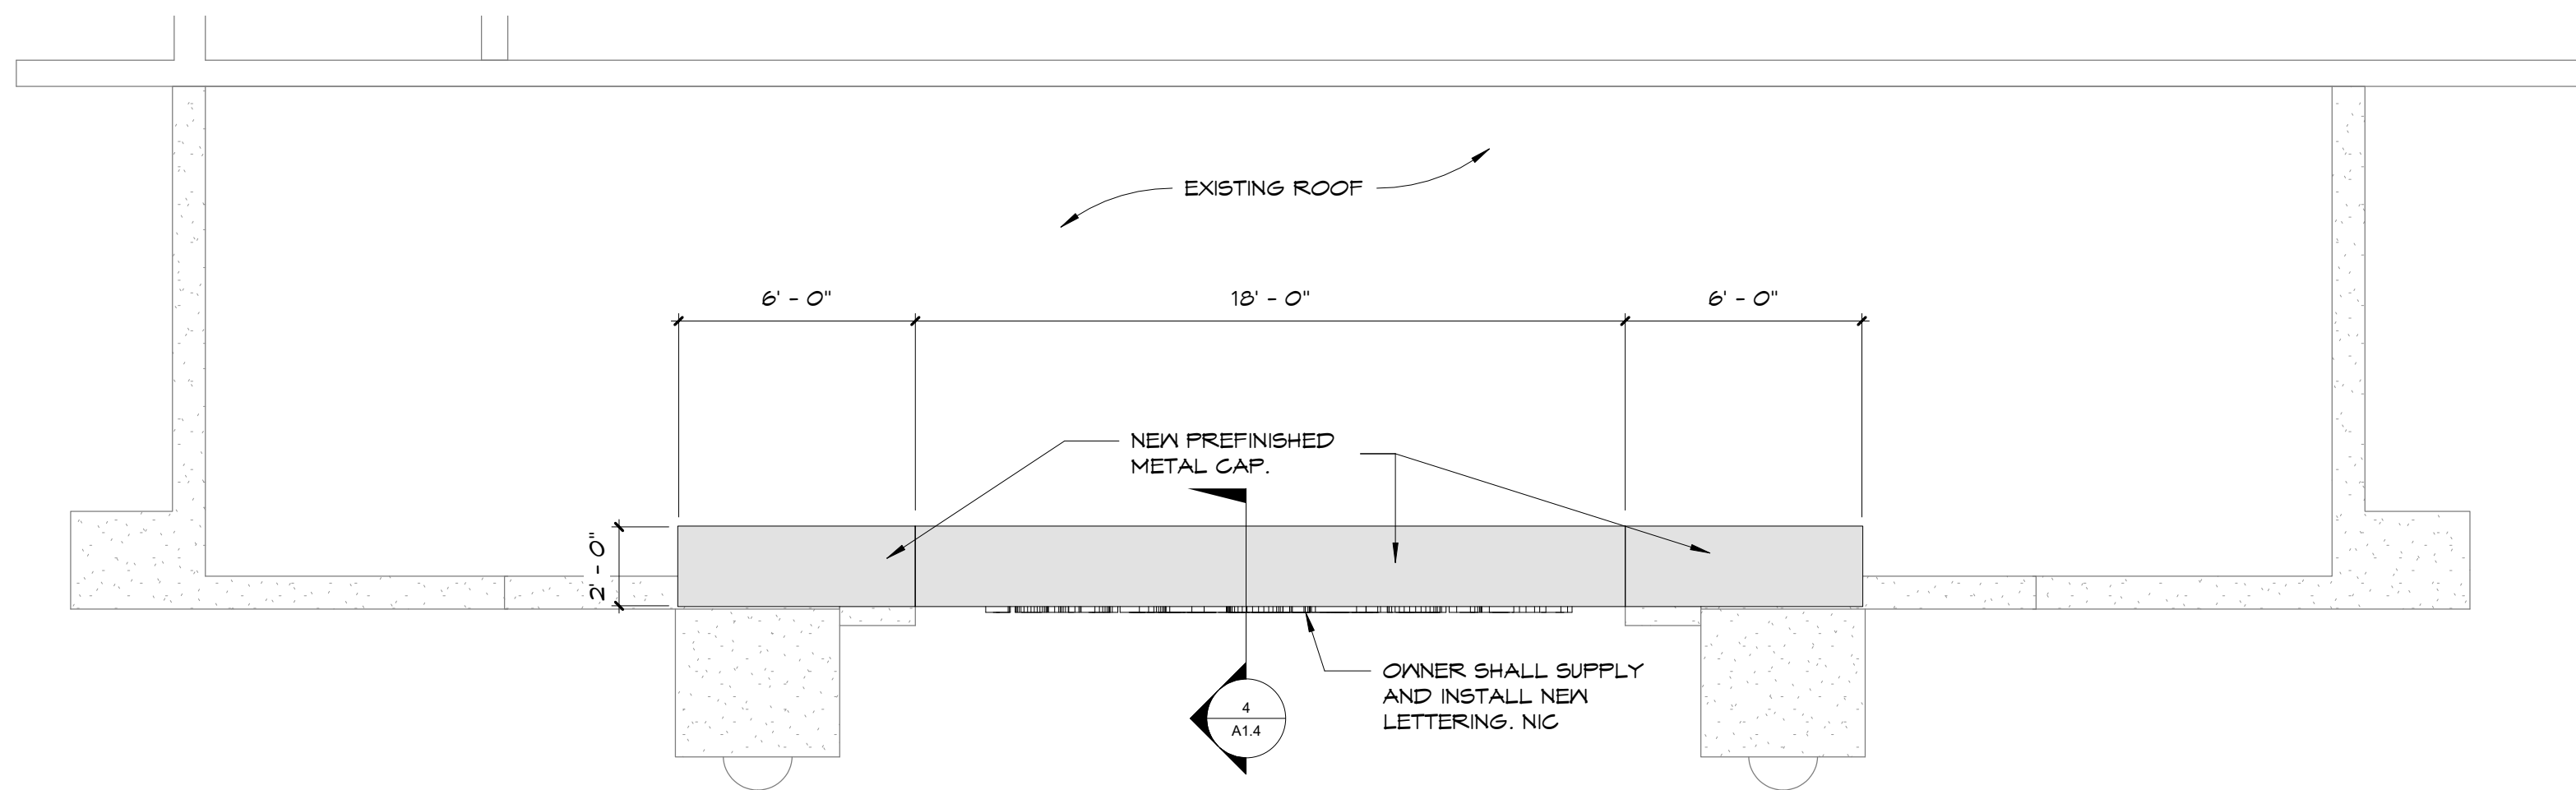


3 ROOF PLAN - SOUTH ENTRANCE
1/4" = 1'-0"

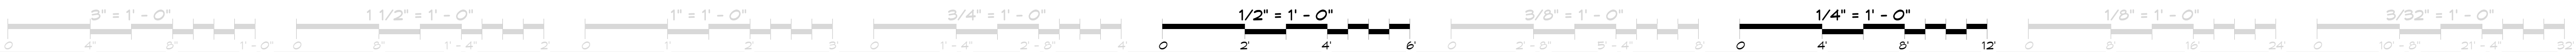


REVISION SCHEDULE		
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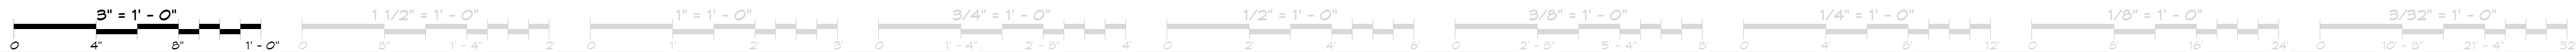
3 METAL FLASHING TO BLOCK SILL/JAMB DETAIL TYP.
3" = 1'-0"

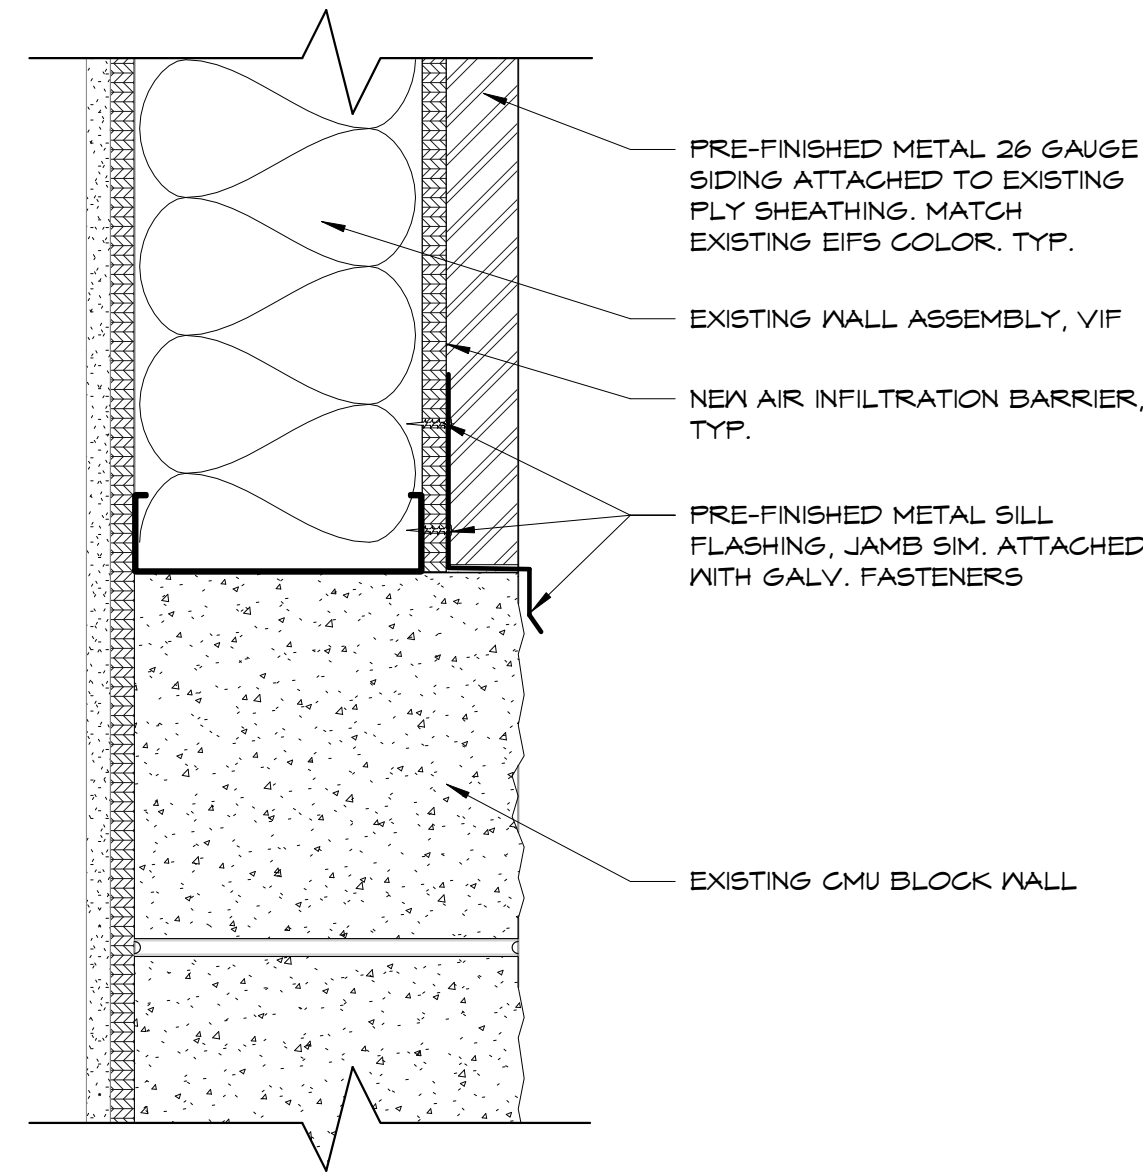

2 PREFINISHED METAL PARAPET CAP 2
3" = 1'-0"

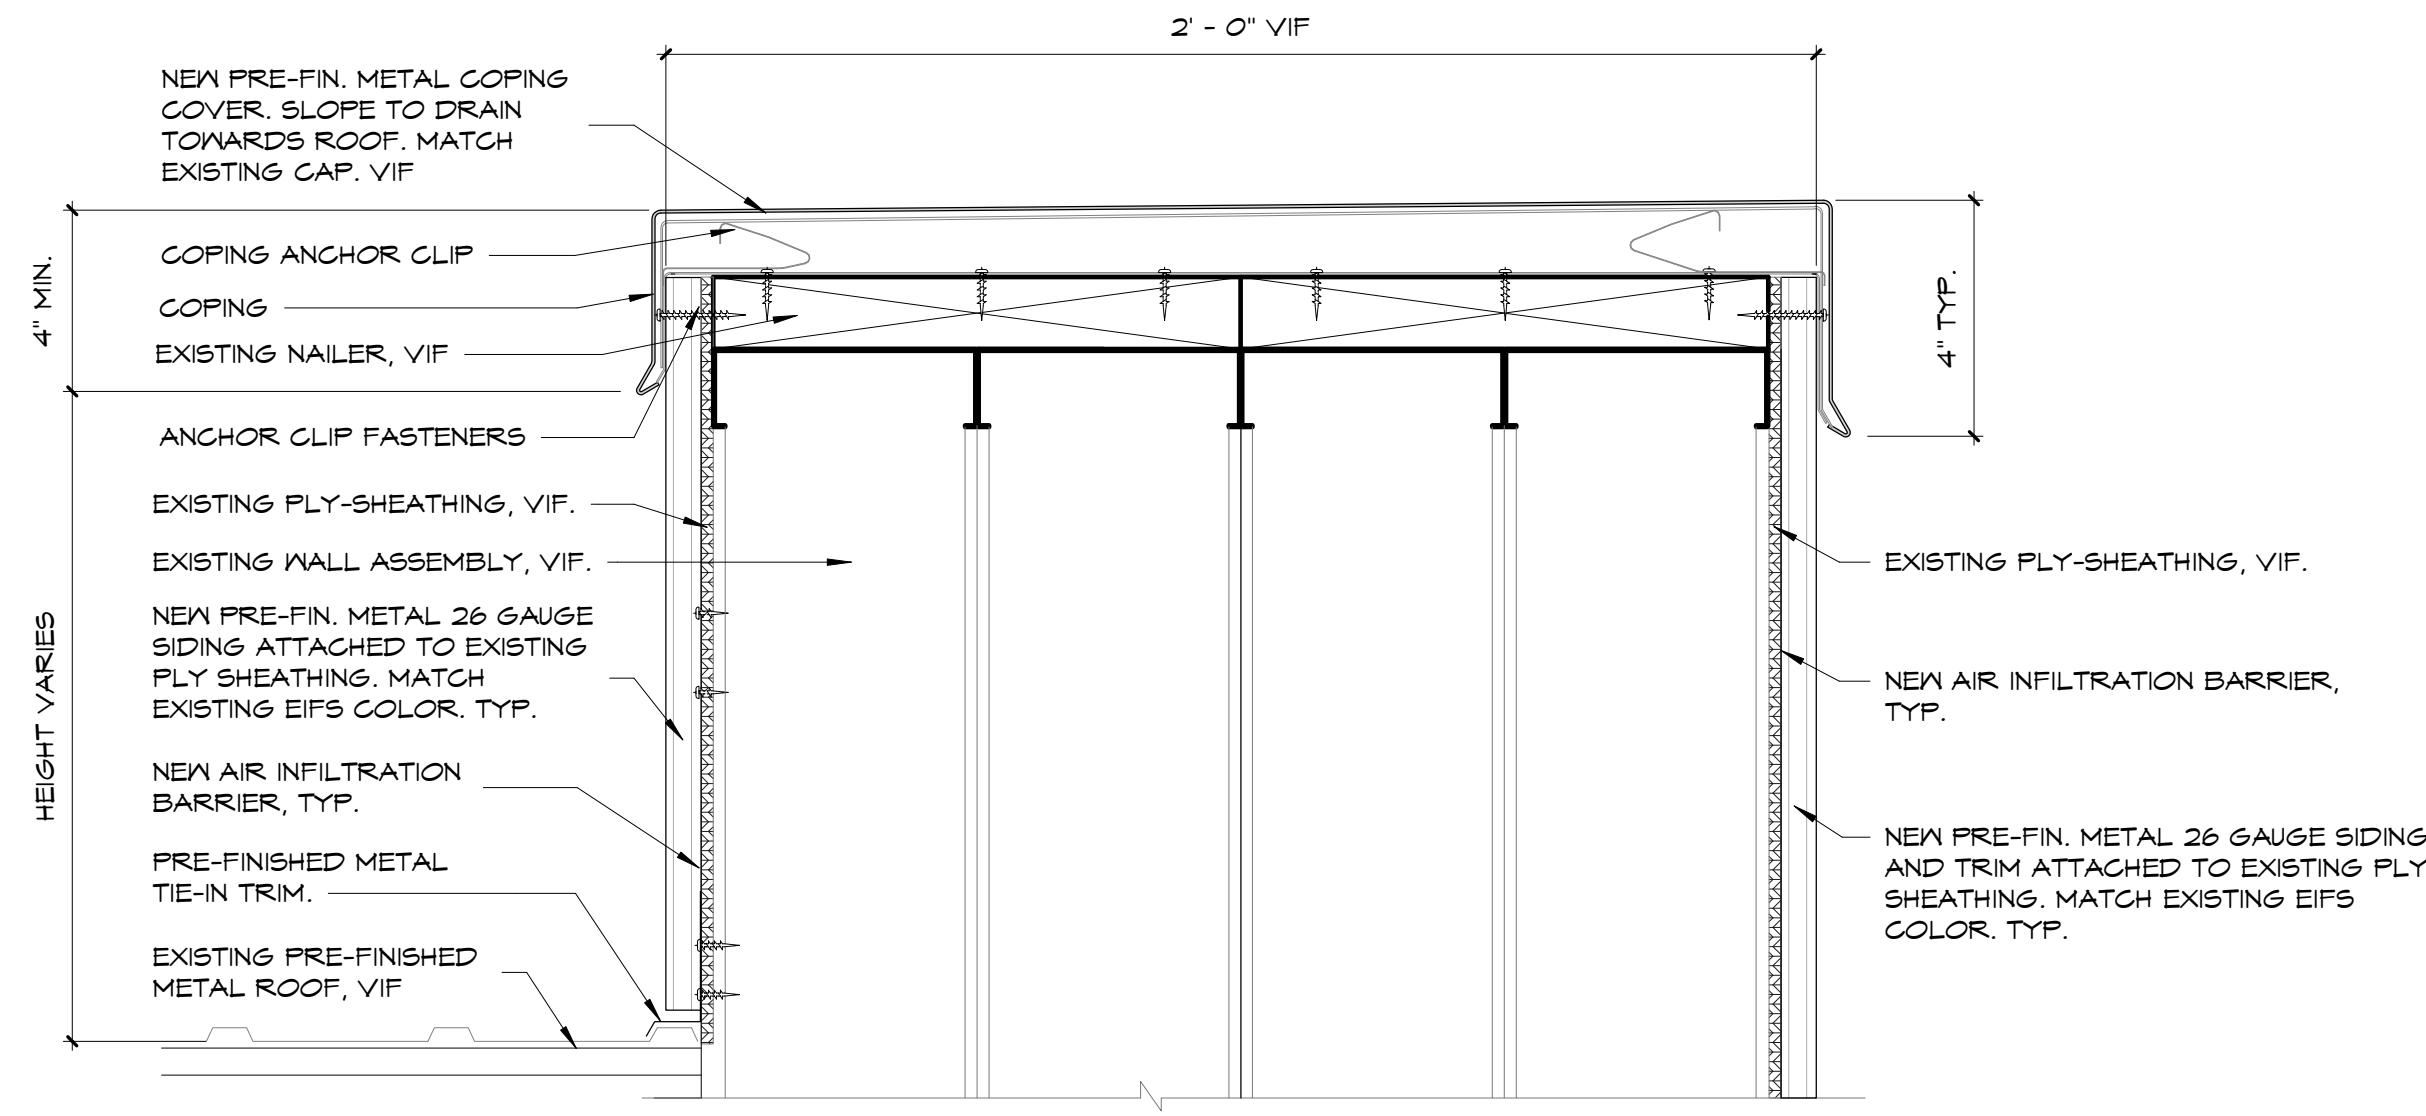

1 PREFINISHED METAL PARAPET CAP 1
6" = 1'-0"

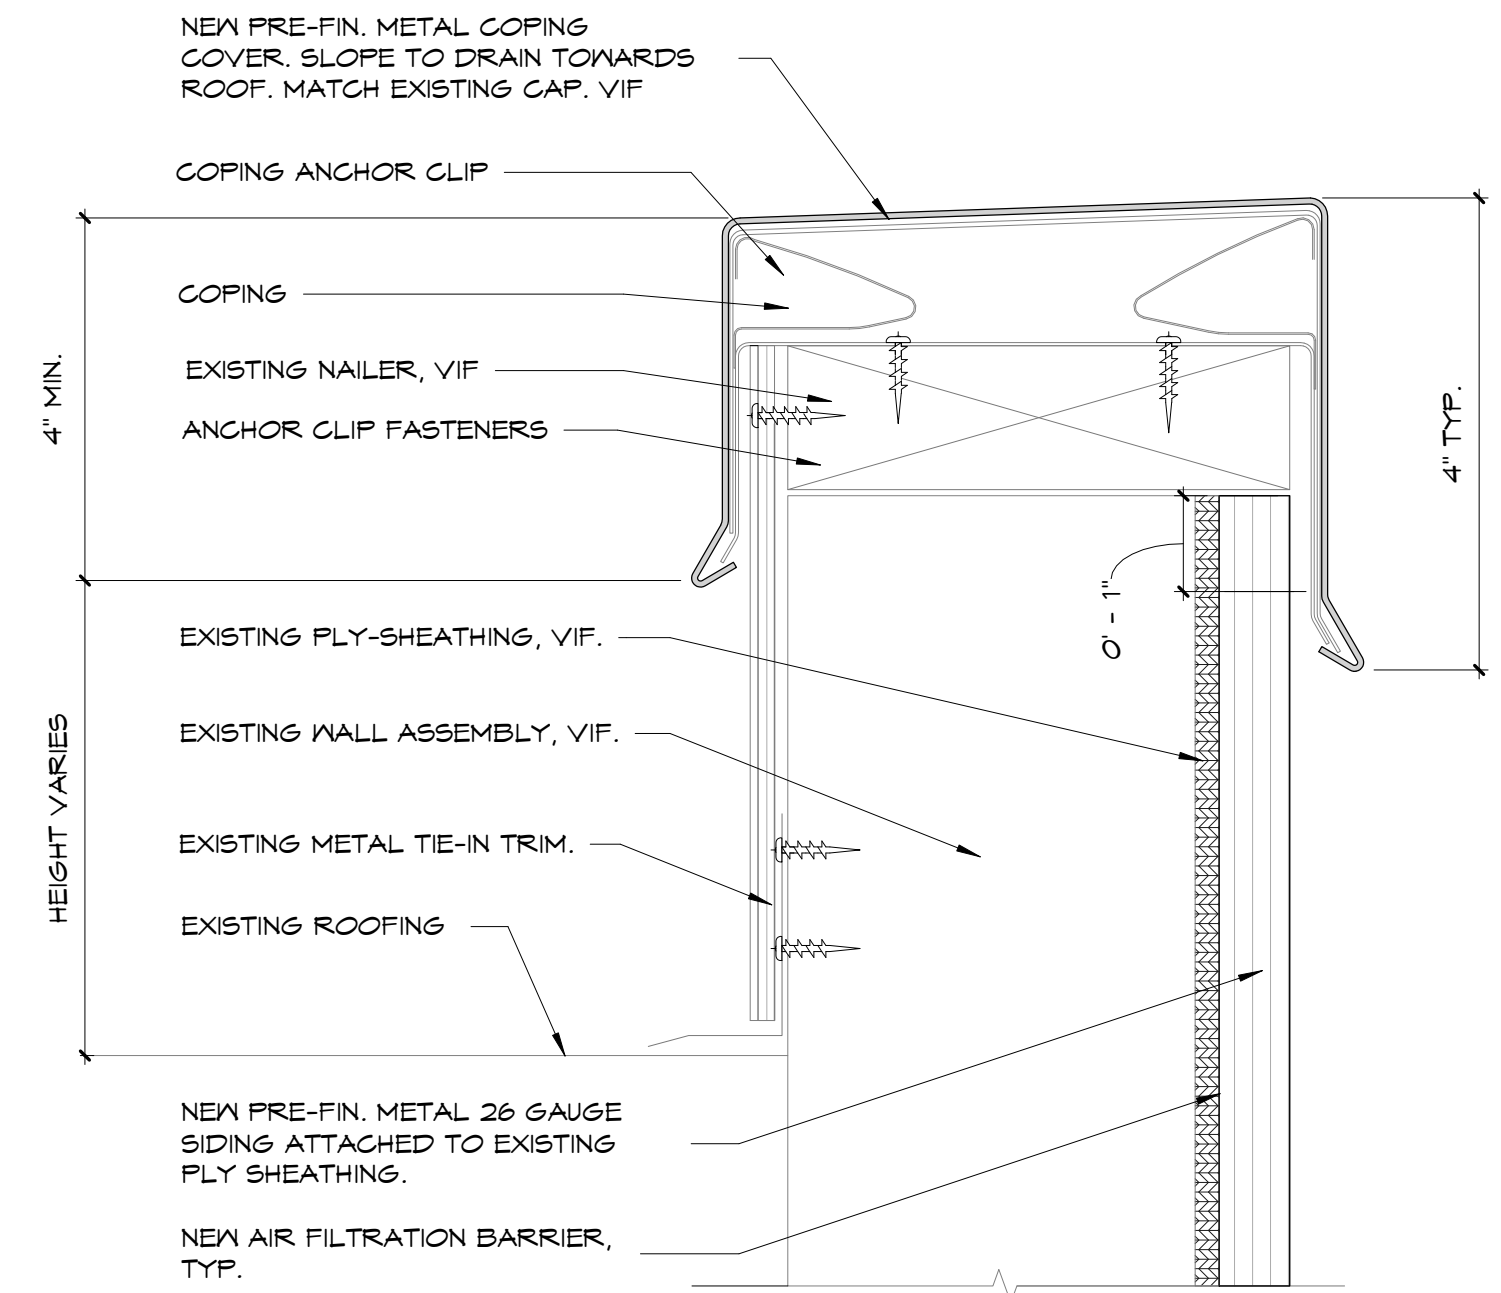

PACIFIC STEEL & RECYCLING
ARENA

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SECTION DETAILS

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A1.5

ISSUED FOR
☒ NOT FOR CONST.
☐ CONSTRUCTION

Nelson architects
Dream Design Build
621 2nd Avenue North
Great Falls, MT 59401
406.727.3286 • NelsonArchitects.com